Brittany Howard Code Enforcement planner@townofepping.com



Town Hall 157 Main Street Epping, NH 03042

Tel: (603) 679-1224 Fax: (603) 679-3002

Town of Epping, New Hampshire Community Planning and Development

April 17, 2019

Rockingham Planning Commission 156 Water Street Exeter, NH 03833

RE: Regional Impact

To Whom It May Concern,

On April 11, 2019 the Planning Board voted to consider the site plan for an asphalt plan by Sam Patterson Real Estate Development LLC a regional impact; please review the attached draft minutes and plans. The meeting will be May 9, 2019. I can be reached at 679-1224 ext 33 or planner@townofepping.com with any questions.

Respectfully Submitted,

Brittany Howard

Code Enforcement Officer

Cc: Fremont

PUBLIC HEARING: Site Plan - Asphalt Plant

Owner/developer: Sam Patterson Real Estate Dev., LLC Location: Shirking Road, Tax Map 035 – Lot 026-002

Chairman Foley read notice of a site plan for an asphalt plant on Shirking Road. Abutters present: none.

Clark motioned to accept the plan Reinhold seconded. Motion passed unanimously 5-0.

Joe Coronati from Jones and Beach was representing Sam Patterson the property owner. Coronati went over the history of the lot. The property is in the industrial commercial zone. There are many industrial and commercial uses. New England Paving has relocated to the lot in front of the lot of the proposed asphalt plant. The roadway leading to site is complete up to gravel. New England Paving recycles the pavement from various projects. The proposed plant is portable but would be permanent at this site. Asphalt is made with sand, gravel and/or recycled asphalt. This plant would allow them to recycle the asphalt they have from projects. This is not a large commercial operation. They cannot complete with Pike or Continental; this is going to be small use mostly by the owner. They will have to buy all their own material; they do not have their own pits.

The proposed plant is an AZTEC six pack. It is brought in on 6 or 7 trailers and can be used temporarily. They are proposing a permanent use. The roadway into the site is one way. They back of the property is where the material will be stock piled to create a buffer for abutters. The grading on the site will be changed so that the site will drain toward the road and not toward the abutters. The area between the roadway and the site will be a bioretention pond for treatment not infiltration. It goes from there to a wet pond and then another swale so any water from the site will be treated at 3 separate areas.

Three components go into making asphalt, sand, gravel, and liquid asphalt. Liquid asphalt is hard when it isn't heated. Drinking water pipes, water tanks are lined with liquid asphalt. This site will be mainly used for New England Paving, they do parking lots and driveways. The do not do roads. They currently leave the site empty but by having this plant they could leave the site with asphalt.

Chairman Foley asked how many tons they would make in a day. Sam Patterson stated on a good day it is 400 ton but typically it is 100 ton. The trucks carry 20 ton.

Coronati stated that the stated that the Zoning Ordinance requires the operation be in a building. The proposal is that the area of the plant that mixes the material will be inside but the areas where the materials are placed in and the conveyor belts are not within the building. The site will be paved for dust control and a cleaner site. There will be a generator and a small office. There will be a port-a-potty and the ability to use the building on the other site. The heating system will run on propane.

Chairman Foley asked about the emission from the site. Coronati stated that they have applied for and received their permit from air emission department part of NHDES, at the state level.

Clark asked why it is a temporary permit. Coronati stated the permit is good until 2020. They have to get the plant up and running and the state comes down to monitor the plant. The plants have to meet air emission. There is not grandfathering. All plants have to meet the air emission standards.

Clark asked what they do with their current recycled asphalt. Sam Patterson stated that they bring it back to their site, screen it, crush it and use it as a gravel product. With the asphalt plant we can reheat it and use it more permanently. Coronati stated that recycled asphalt is also used on dirt roads. Clark Patterson spoke about emissions. The more efficient the plant the cleaner the emission, steam is what comes out of the stack. Asphalt does not containment water.

Chairman Foley stated that this site is very close to the border and that the access is out through Fremont. Does the Board think this is a regional impact development? All members agreed that it is. The Board wants the regional planning commission to be involved as well as the surrounding communities.

Chairman Foley opened the meeting to the public.

Scott Barthelemy – Fremont. Barthelemy believes that they are hardworking men. They are good neighbors. He has concerns about the smell. When they received the original approval, they stated it would be a paving prep site not an asphalt plant.

Coronati stated that this plant will not be running all the time. It is a small operation. They make it on the spot. We will get more information on smell.

Clark asked what the life of the plant is. Clark Patterson stated wear and tear parts need to be replaced more regularly but other part may last forever. Clark then asked if they have future plans to turn this into a permanent plant that can make more asphalt Clark Patterson stated that their permit is only for a certain amount of asphalt and they don't plan on requesting more. We are not trying to pave 101, we cannot complete with the bigger companies.

Mary Fosel – Fremont Road – They are good neighbors. There is an issue with traffic and full trucks. Right now, they can't go Railroad Ave. They can't go through Fremont. They are going down St. Laurent Street to Main Street and the roads are too small. There are also concerns about smell coming from the site.

Mark Vallone, 252 Blake Road. What if 20 years from now Pike wants to buy them out and increase the operation on the site. Howard stated that the Board can stipulate that they can only produce a certain amount and if they want to exceed that amount, they would need site plan approval.

Vallone also asked what the plan is to mitigate the air pollution. Coronati stated there is an air emission permit from the state. This is not an unregulated situation where something is happening in your town without oversite. The stack is up 35 feet in the air. Clark Patterson then explains this plant will have a bag house, similar to a diesel engine with an after burner. It is equivalent to 12 wood stoves burning a year. The bag house is a large filter system. The material that is in the filter and gets fed back into the fire.

Vallone asked how the site in monitored. Clark Patterson stated that they do a stack test and drive by test. The state can tell by the color of your emission if you are burning clean. A lot of the smell you get from an asphalt plant is when plants are recycling shingles. Howard stated the Board can restrict the recycling of shingles on the site.

Cary Cloutier, Martin Road Fremont. Last week he informed the Town Administrator about the meeting. The Town Administrator and the Board of Selectmen did not know about the meeting. This is a regional impact and does impact Fremont and the residents. North Road- no thru trucking. Martin Road no through trucking and there is weight limit because of the bridge. A number of residents on Martin Road are unhappy with the amount of trucks every day. Many residents in Epping will be unhappy with all the traffic because residents in Fremont are going to get Shirking Road restricted which mean all traffic will go through Epping.

Joe Jean 27 Fremont Road. Is very concerned with the smell. Shirking Road may be industrial commercial but is sandwiched in between residential. I very rarely see New England Paving trucks coming past my property but there are concerns about the smell.

Howard read the letter from the Town of Fremont's Town Administrator into the record. There are concerns about traffic and the conditions of the road, concerns about air and water quality.

Chairman Foley stated that the applicant should reach out the other communities that have a similar plant, so that Board members of abutters may dry by the plant and see about smell. Clark Patterson stated that you should only be able to smell it when the material is dropped into the trucks. Chairman Foley has concerns about Shirking Road and the traffic.

Coronati then showed the Board Fremont Zoning map. All the traffic from the Industrial Zone in Fremont will be going through Epping.

Dennis Howland – Zoning Board of Appeals in Fremont. The ZBA denied an asphalt plant in Fremont because of traffic. We weren't worried about smells, emissions, or contamination. It was denied because of the impact to the residences in the area and the traffic.

Clark motion Reinhold seconded to continue the meeting to May 9th. The motion passed unanimously.

PUBLIC HEARING: Site Plan - Solar

Owner/developer: Route 125 & 101 Investments

Location: Fresh River Road, Tax Map 29 – Lots 283-006

Chairman Foley read notice of a site plan for an asphalt plant on Shirking Road. Abutters present: none.


Clark motion Reinhold seconded to accept the plans; motion passed unanimously.

Paige Libby from Jones and Beach represented Route 125 and 101 Investments. The shed will no long be in the right-of-way. The site will need a condition use permit for wetland and wetland

GENERAL LEGEND DRAINAGE LINE SEWER FORCE MAIN IRON PIPE/IRON ROD DRILL HOLE IRON ROD/DRILL HOLE STONE/GRANITE BOUND × 100.00 × 100.00 PAVEMENT SPOT GRADE CURB SPOT GRADE BENCHMARK (TBM) DOUBLE POST SIGN SINGLE POST SIGN FAILED TEST PIT MONITORING WELL PERC TEST PHOTO LOCATION UTILITY POLE LIGHT POLES DRAIN MANHOLE SEWER MANHOLE WATER SHUT OFF REDUCER SINGLE GRATE CATCH BASIN DOUBLE GRATE CATCH BASIN CULVERT W/WINGWALLS =CULVERT W/FLARED END SECTION =₩₩ ₩ CULVERT W/STRAIGHT HEADWALL STONE CHECK DAM DRAINAGE FLOW DIRECTION 4K SEPTIC AREA WETLAND IMPACT XXXXX VEGETATED FILTER STRIP RIPRAP OPEN WATER जीह जीह FRESHWATER WETLANDS TIDAL WETLANDS STABILIZED CONSTRUCTION **ENTRANCE** CONCRETE GRAVEL

SITE PLAN NEW ENGLAND PAVING ASPHALT PLANT

TAX MAP 35, LOT 26-2 SHIRKING ROAD, EPPING, NH

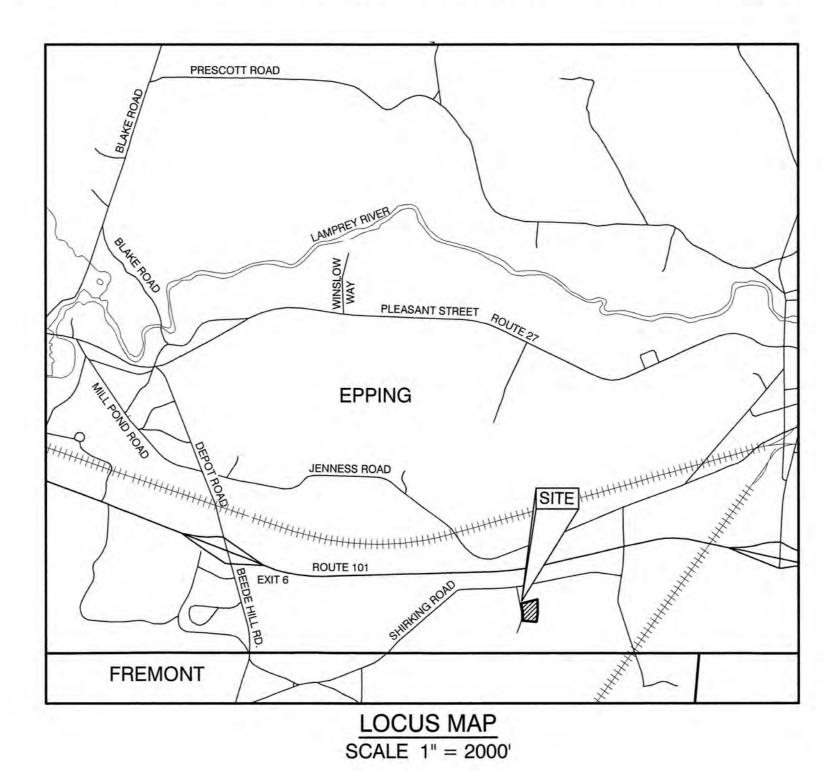

SHEET INDEX

S COVER SHEET

C1 EXISTING CONDITIONS PLAN

C2 SITE PLAN

C3 GRADING, DRAINAGE & UTILITY PLAN

1 LIGHTING PLAN

D1 DETAIL SHEET

1 EROSION AND SEDIMENT CONTROL DETAILS

CIVIL ENGINEER / SURVEYOR/

WETLAND CONSULTANT
JONES & BEACH ENGINEERS, INC.
85 PORTSMOUTH AVENUE
PO BOX 219
STRATHAM, NH 03885
(603) 772-4746
CONTACT: JOSEPH CORONATI
EMAIL: JCORONATI@JONESANDBEACH.COM

SOIL CONSULTANT
GOVE ENVIRONMENTAL SERVICES, INC.
8 CONTINENTAL DRIVE, UNIT H
PO BOX 219
EXETER, NH 03833
(603) 778-0644
CONTACT: JIM GOVE, CWS, CSS
EMAIL: JGOVE@GESINC.BIZ

PSL

BY

Stratham, NH 03885

ELECTRIC

EVERSOURCE ENERGY
74 OLD DOVER ROAD
ROCHESTER, NH 03867
(603) 555 - 5334
CONTACT: LINDA FARRAR

TELEPHONE
FAIRPOINT COMMUNICATIONS
100 TRI CITY ROAD
SOMERWORTH, NH 03878

(603) 743-1114 CONTACT: DAVE KESTNER

CABLE TV
COMCAST COMMUNICATION CORPORATION
334-B CALEF HIGHWAY
EPPING, NH 03042-2325
(603) 679-5695

E-MAIL: JBE@JONESANDBEACH.COM

PROJECT PARCEL
TOWN OF EPPING
TAX MAP 35, LOT 26-2
BK 5976, PG 1989

TOTAL LOT AREA 130,849 SQ. FT. 3.00 ACRES

APPROVED - EPPING, NH PLANNING BOARD


DATE:

Design: JAC Draft: PSL Date: 3/21/19
Checked: JAC Scale: AS NOTED Project No.: 14161.3
Drawing Name: 14161-PLAN-LOT26-2.dwg
THIS PLAN SHALL NOT BE MODIFIED WITHOUT WRITTEN

SNOW STORAGE

RETAINING WALL

THIS PLAN SHALL NOT BE MODIFIED WITHOUT WRITTEN
PERMISSION FROM JONES & BEACH ENGINEERS, INC. (JBE).
ANY ALTERATIONS, AUTHORIZED OR OTHERWISE, SHALL BE
AT THE USER'S SOLE RISK AND WITHOUT LIABILITY TO JBE.

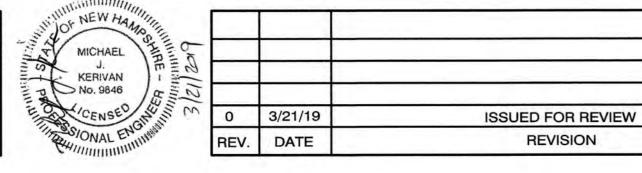

Designed and Produced in NH

Jones & Beach Engineers, Inc.

85 Portsmouth Ave. Civil Engineering Services
PO Box 219

Designed and Produced in NH

Engineers, Inc.

603-772-4746
FAX: 603-772-0227

Plan Name:

COVER SHEET

NEW ENGLAND PAVING ASPHALT PLANT
30 SHIRKING ROAD, EPPING, NH

Owner of Record:


SAM PATTERSON REAL ESTATE DEV., LLC
PO BOX 2793, SEABROOK, NH 03874

DRAWING No.

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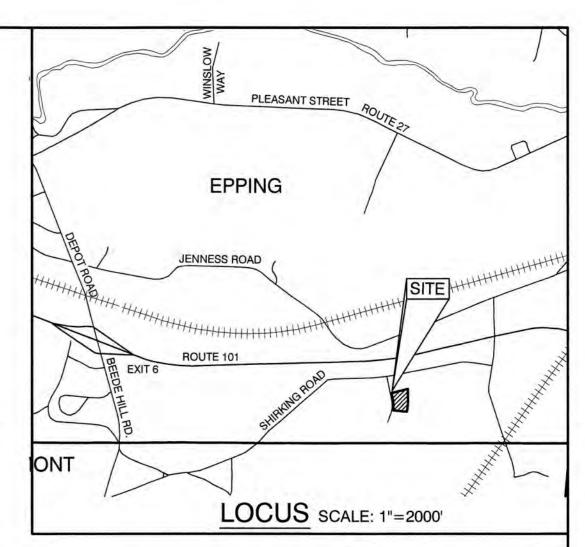
SHEET 1 OF 7

JBE PROJECT NO. 14161.3

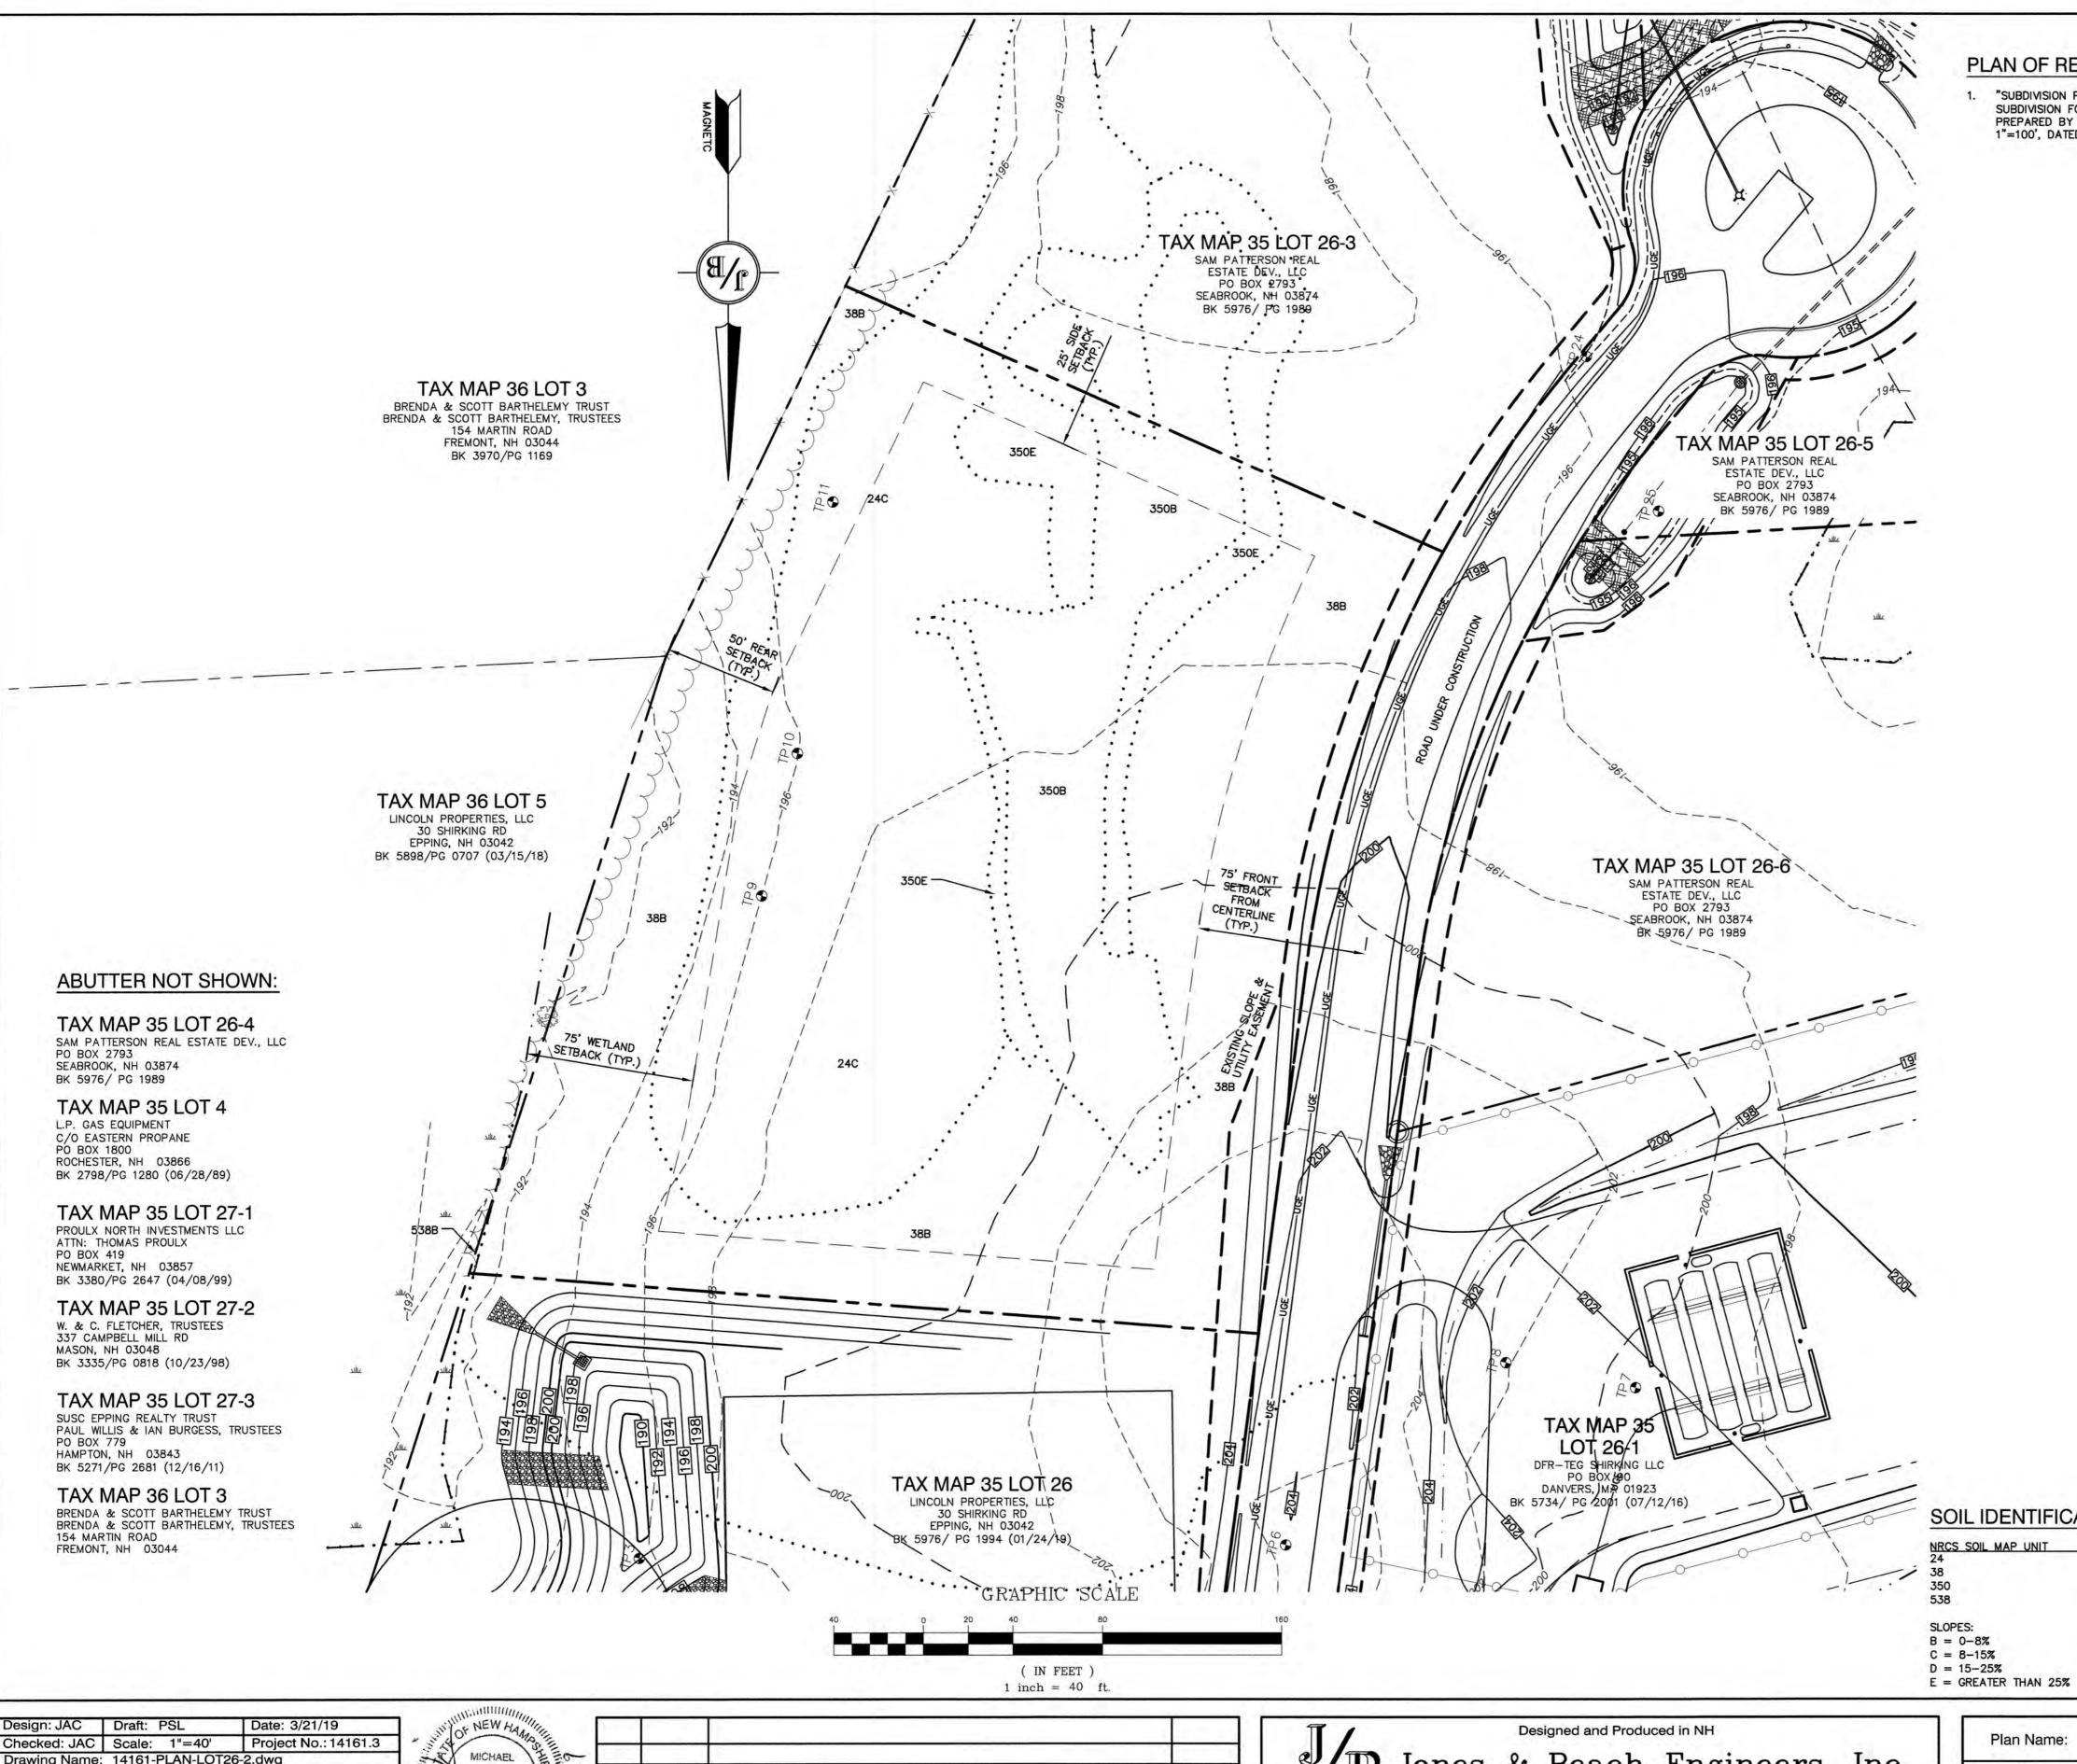

PLAN OF REFERENCE:

"SUBDIVISION PLAN, SHIRKING ROAD INDUSTRIAL PARK SUBDIVISION FOR PATTERSON REAL ESTATE, LLC", PREPARED BY JONES & BEACH ENGINEERS, INC., SCALE 1"=100', DATED AUGUST 22, 2016, R.C.R.D. #D-40504.



EXISTING CONDITIONS & DEMOLITION NOTES:

- UNDERGROUND FACILITIES, UTILITIES AND STRUCTURES HAVE BEEN PLOTTED FROM FIELD OBSERVATION AND THEIR LOCATION MUST BE CONSIDERED APPROXIMATE ONLY. NEITHER JONES & BEACH ENGINEERS, INC., NOR ANY OF THEIR EMPLOYEES TAKE RESPONSIBILITY FOR THE LOCATION OF ANY UNDERGROUND STRUCTURES OR UTILITIES NOT SHOWN THAT MAY EXIST. IT IS THE RESPONSIBILITY OF THE CONTRACTOR TO HAVE ALL UNDERGROUND STRUCTURES AND/OR UTILITIES LOCATED PRIOR TO EXCAVATION WORK BY CALLING 1-888-DIG-SAFE (1-888-344-7233).
- 2. HORIZONTAL DATUM: MAGNETIC VERTICAL DATUM: NGVD29
- 3. SUBJECT PROPERTY IS NOT LOCATED WITHIN FEDERALLY DESIGNATED 100 YEAR FLOOD HAZARD ZONE. REFERENCE FEMA COMMUNITY PANEL NO. 33015C 0215 E, DATED MAY 17, 2005.
- 4. THE LIMITS OF JURISDICTIONAL WETLANDS WERE DELINEATED BY CHRISTOPHER ALBERT OF JONES & BEACH ENGINEERS, INC. DURING SPRING, 2015, IN ACCORDANCE WITH THE FOLLOWING GUIDANCE DOCUMENTS:
- a. THE CORPS OF ENGINEERS FEDERAL MANUAL FOR IDENTIFYING AND DELINEATING JURISDICTIONAL WETLANDS.
- b. THE NORTH CENTRAL & NORTHEAST REGIONAL SUPPLEMENT TO THE FEDERAL
- c. THE CURRENT VERSION OF THE FIELD INDICATORS FOR IDENTIFYING HYDRIC SOILS IN NEW ENGLAND, AS PUBLISHED BY THE NEW ENGLAND INTERSTATE WATER POLLUTION CONTROL COMMISSION AND/OR THE CURRENT VERSION OF THE FIELD INDICATORS OF HYDRIC SOILS IN THE UNITED STATES, AS PUBLISHED BY THE USDA, NRCS, AS APPROPRIATE.
- d. THE CURRENT NATIONAL LIST OF PLANT SPECIES THAT OCCUR IN WETLANDS, AS PUBLISHED BY THE US FISH AND WILDLIFE SERVICE.
- IN AREAS WHERE CONSTRUCTION IS PROPOSED ADJACENT TO ABUTTING PROPERTIES, THE CONTRACTOR SHALL INSTALL ORANGE CONSTRUCTION
 FENCING ALONG PROPERTY LINES IN ALL AREAS WHERE SILT FENCING IS NOT
- 5. EROSION AND SEDIMENTATION CONTROL MEASURES SHALL BE INSTALLED PRIOR TO CONSTRUCTION AND ANY EARTH MOVING OPERATIONS. SILT FENCE SHALL BE INSTALLED AT THE LIMITS OF IMPACT AREAS ACCORDING TO THE DETAILS SHOWN ON SHEET E1.
- WETLAND BOUNDARIES AND CONSTRUCTION LIMITS ARE TO BE CLEARLY MARKED PRIOR TO THE START OF CONSTRUCTION.
- EXCAVATED MATERIALS WILL BE PLACED WITHIN UPLAND AREAS AS FILL MATERIAL OR HAULED OFF-SITE FOR DISPOSAL IN AN APPROPRIATE UPLAND
- 8. THE SITE SPECIFIC SOIL SURVEY WAS PRODUCED OCTOBER 12, 2016, AND WAS PREPARED BY JAMES P. GOVE, CSS # 004, GOVE ENVIRONMENTAL SERVICES, INC. SOILS WERE IDENTIFIED WITH THE NEW HAMPSHIRE STATE—WIDE NUMERICAL SOILS LEGEND, USDA NRCS, DURHAM, NH. ISSUE # 10, JANUARY


SOIL IDENTIFICATION LEGEND

NRCS SOIL SERIES
AGAWAM ELDRIDGE UDIPSAMMENTS, WET SUBSTRATUM SQUAMSCOTT SLOPES: B = 0 - 8%

PROJECT PARCEL TOWN OF EPPING TAX MAP 35, LOT 26-2 BK 5976, PG 1989

> **TOTAL LOT AREA** 130,849 SQ. FT. 3.00 ACRES

Checked: JAC | Scale: 1"=40' Drawing Name: 14161-PLAN-LOT26-2.dwg THIS PLAN SHALL NOT BE MODIFIED WITHOUT WRITTEN PERMISSION FROM JONES & BEACH ENGINEERS, INC. (JBE). ANY ALTERATIONS, AUTHORIZED OR OTHERWISE, SHALL BE AT THE USER'S SOLE RISK AND WITHOUT LIABILITY TO JBE.

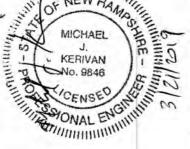

0	3/21/19	ISSUED FOR REVIEW	PSL
REV.	DATE	REVISION	BY

Jones & Beach Engineers, Inc.

85 Portsmouth Ave. Civil Engineering Services PO Box 219 Stratham, NH 03885


FAX: 603-772-0227 E-MAIL: JBE@JONESANDBEACH.COM

603-772-4746

Plan Name:	EXISTING CONDITIONS PLAN
Project:	NEW ENGLAND PAVING ASPHALT PLANT 30 SHIRKING ROAD, EPPING, NH
Owner of Record:	SAM PATTERSON REAL ESTATE DEV., LLC PO BOX 2793, SEABROOK, NH 03874


DRAWING No.

SHEET 2 OF 7 JBE PROJECT NO. 14161.3

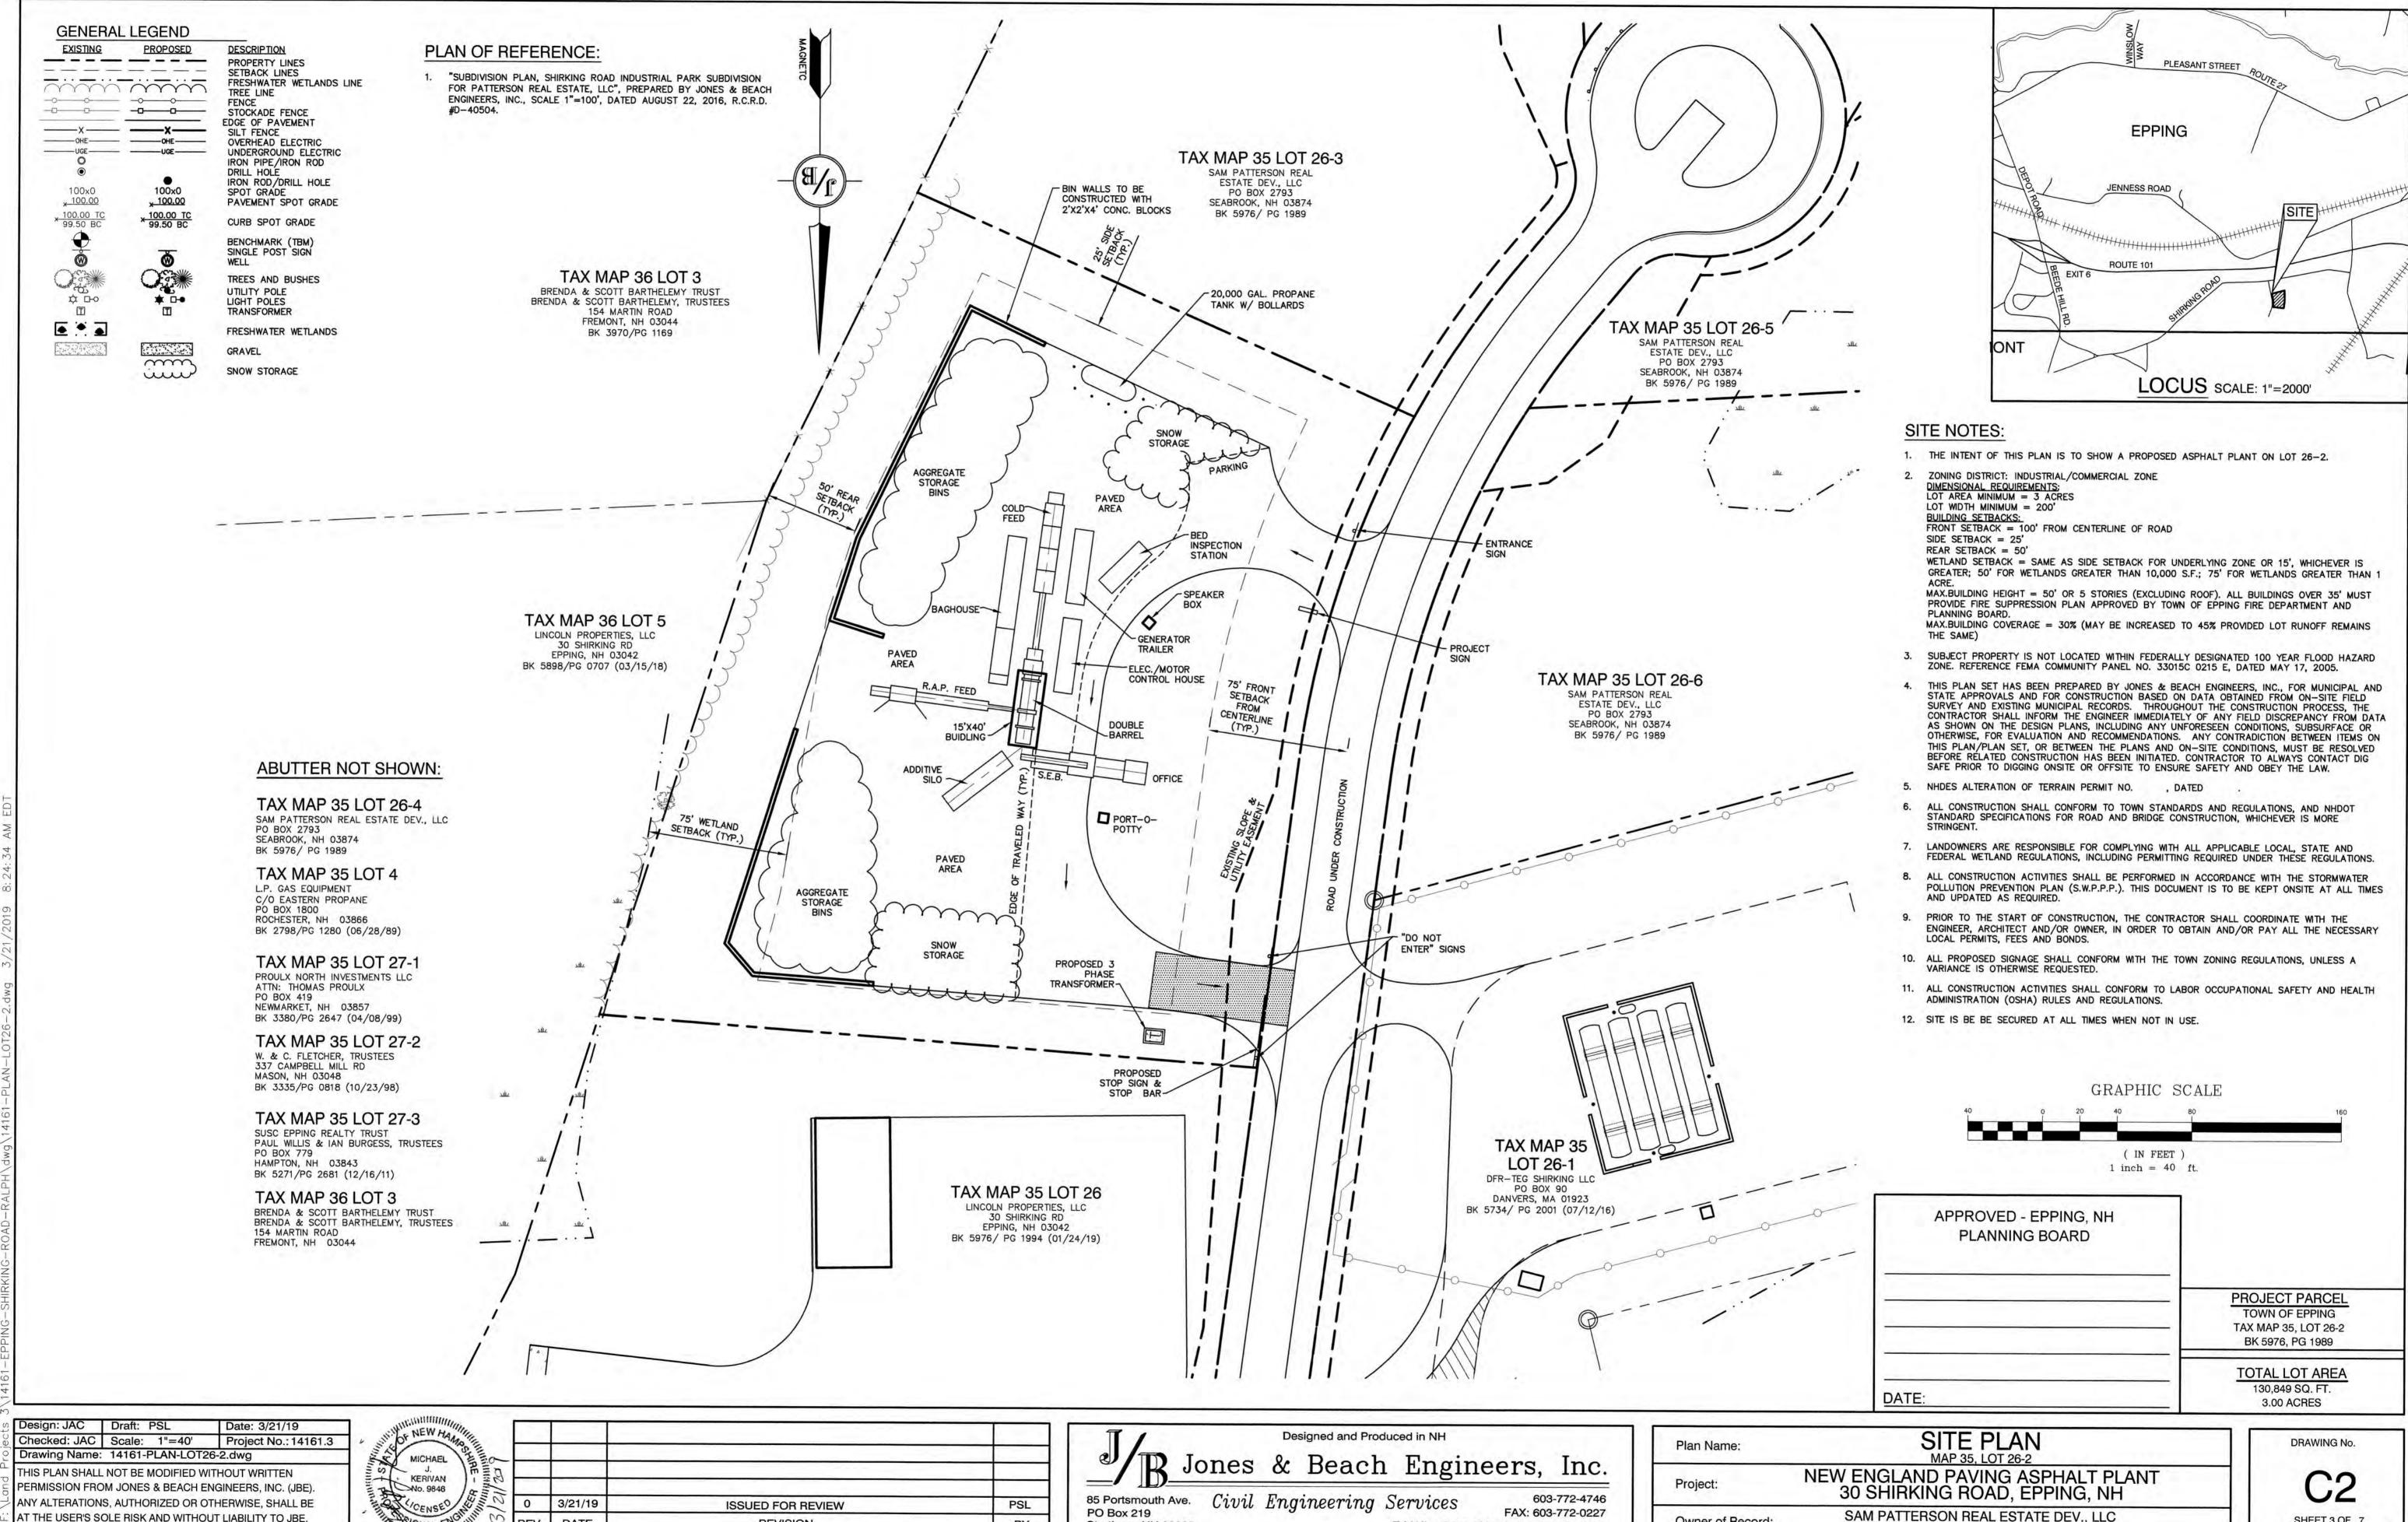

Stratham, NH 03885

AT THE USER'S SOLE RISK AND WITHOUT LIABILITY TO JBE.

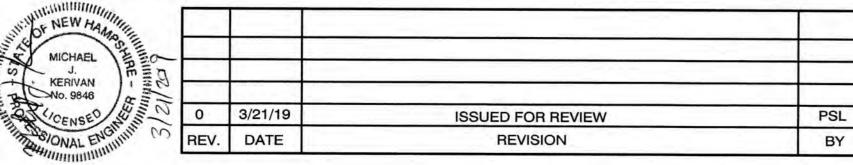

Owner of Record: E-MAIL: JBE@JONESANDBEACH.COM

SHEET 3 OF 7

JBE PROJECT NO. 14161.3

PO BOX 2793, SEABROOK, NH 03874

MATCHLINE Charles of PROPOSED SILT FENCE (TYP.) ROADSIDE DRAINAGE SWALE (UNDER CONSTRUCTION) 20,000 GAL. PROPANE TANK 12" INV. OUT =197.0 W/ HEADWALL AND RIP RAP OUTLET PROTECTION APRQN, d50=3", L=12', MOTOR -CONTROL - PROPOSED 12" HOUSE HDPE DRIVEWAY CULVERT - PROPOSED SILT FENCE (TYP.) BIORETENTION 350E -12" DRAIN BASIN WITH DOMED GRATE RIM=201.5 6" PERF. INV. IN=197.42 12" SOLID HDPE INV. OUT=197.42 L=100', S=0.005 FT/FT 6" PERFORATED PROPOSED 3 PHASE UNDERGROUND POWER TO MOTOR CONTROL UNDERDRAIN INV.=197.42 INCINE DRAIN CLEANOUT RIM=201.5 PROPOSED STABILIZED CONSTRUCTION ENTRANCE - PROPOSED SILT FENCE (TYP.) . * PROPOSED 12" HDPE DRIVEWAY CULVERT X202.83 PROPOSED -/ /3 PHASE TRANSFORMER UNDERGROUND ELECTRIC (UNDER CONSTRUCTION) PROPOSED -UNDERGROUND Design: JAC | Draft: PSL Date: 3/21/19

UTILITY NOTES:

- PRIOR TO THE START OF CONSTRUCTION, THE CONTRACTOR SHALL COORDINATE WITH THE ENGINEER, ARCHITECT AND/OR OWNER, IN ORDER TO OBTAIN AND/OR PAY ALL THE NECESSARY LOCAL PERMITS, CONNECTION FEES AND BONDS.
- 2. A PRECONSTRUCTION MEETING SHALL BE HELD WITH THE OWNER, ENGINEER, ARCHITECT, CONTRACTOR, LOCAL OFFICIALS, AND ALL PROJECT-RELATED UTILITY COMPANIES (PUBLIC AND PRIVATE) PRIOR TO START
- 3. ALL CONSTRUCTION SHALL CONFORM TO THE TOWN STANDARDS AND REGULATIONS, AND NHDES STANDARDS AND SPECIFICATIONS, WHICHEVER ARE MORE STRINGENT, UNLESS OTHERWISE SPECIFIED.
- ALL CONSTRUCTION ACTIVITIES SHALL CONFORM TO LABOR OCCUPATIONAL SAFETY AND HEALTH ADMINISTRATION (OSHA) RULES AND REGULATIONS.
- CONTRACTOR TO FURNISH SHOP DRAWINGS FOR UTILITY RELATED ITEMS TO ENSURE CONFORMANCE WITH THE PLANS AND SPECIFICATIONS. SHOP DRAWINGS SHOULD BE SENT IN TRIPLICATE TO THE DESIGN ENGINEER FOR REVIEW AND APPROVAL PRIOR TO INSTALLATION.
- 6. EXISTING UTILITIES SHALL BE DIGSAFED BEFORE CONSTRUCTION.
- 7. LIGHTING CONDUIT SHALL BE SCHEDULE 40 PVC, AND SHALL BE INSTALLED IN CONFORMANCE WITH THE NATIONAL ELECTRIC CODE. CONTRACTOR SHALL PROVIDE EXCAVATION AND BACKFILL.
- ALL TRENCHING, PIPE LAYING, AND BACKFILLING SHALL BE IN ACCORDANCE WITH FEDERAL OSHA REGULATIONS.

MATCHLINE

FAX: 603-772-0227

E-MAIL: JBE@JONESANDBEACH.COM

GRADING AND DRAINAGE NOTES:

- UNDERGROUND FACILITIES, UTILITIES AND STRUCTURES HAVE BEEN PLOTTED FROM FIELD OBSERVATION AND THEIR LOCATION MUST BE CONSIDERED APPROXIMATE ONLY. NEITHER JONES & BEACH ENGINEERS, INC., NOR ANY OF THEIR EMPLOYEES TAKE RESPONSIBILITY FOR THE LOCATION OF ANY UNDERGROUND STRUCTURES AND/OR UTILITIES NOT SHOWN THAT MAY EXIST. IT IS THE RESPONSIBILITY OF THE CONTRACTOR TO HAVE ALL UNDERGROUND STRUCTURES AND/OR UTILITIES LOCATED PRIOR TO EXCAVATION WORK BY CALLING 888-DIG-SAFE (888-344-7233).
- 2. VERTICAL DATUM: NGVD29. HORIZONTAL DATUM: MAGNETIC.
- 3. ALL BENCHMARKS AND TOPOGRAPHY SHOULD BE FIELD VERIFIED BY THE CONTRACTOR.
- 4. SITE GRADING SHALL NOT PROCEED UNTIL EROSION CONTROL MEASURES HAVE BEEN INSTALLED. SEE CONSTRUCTION SEQUENCE
- 5. ALL STORMWATER MANAGEMENT AREAS ARE TO BE STABILIZED PRIOR TO DIRECTING RUNOFF TO THEM.
- 6. ALL DRAINAGE STRUCTURES SHALL BE PRECAST, UNLESS OTHERWISE SPECIFIED.

WHERE SILT FENCING IS NOT REQUIRED.

ON SHEET E1.

- ALL DRAINAGE STRUCTURES AND STORM SEWER PIPES SHALL MEET HEAVY DUTY TRAFFIC H20 LOADING AND SHALL BE INSTALLED ACCORDINGLY.
- 8. IN AREAS WHERE CONSTRUCTION IS PROPOSED ADJACENT TO ABUTTING PROPERTIES, THE CONTRACTOR SHALL INSTALL ORANGE CONSTRUCTION FENCING ALONG PROPERTY LINES IN ALL AREAS
- 9. ALL DRAINAGE PIPE SHALL BE NON-PERFORATED ADS N-12 OR APPROVED EQUAL.
- 10. LAND DISTURBING ACTIVITIES SHALL NOT COMMENCE UNTIL APPROVAL TO DO SO HAS BEEN RECEIVED BY ALL GOVERNING AUTHORITIES. THE GENERAL CONTRACTOR SHALL STRICTLY ADHERE TO THE EPA SWPPP DURING CONSTRUCTION OPERATIONS.
- 11. NO LAND CLEARING OR GRADING SHALL BEGIN UNTIL ALL EROSION CONTROL MEASURES HAVE BEEN INSTALLED.
- 12. ALL EXPOSED AREAS SHALL BE SEEDED AS SPECIFIED WITHIN 3 DAYS OF FINAL GRADING.
- 13. SHOULD CONSTRUCTION STOP FOR LONGER THAN 3 DAYS, THE SITE SHALL BE SEEDED AS SPECIFIED.
- 14. MAINTAIN EROSION CONTROL MEASURES AFTER EACH RAIN EVENT OF 0.25" OR GREATER IN A 24 HOUR PERIOD AND AT LEAST
- 15. THIS PLAN SHALL NOT BE CONSIDERED ALL INCLUSIVE, AS THE GENERAL CONTRACTOR SHALL TAKE ALL NECESSARY PRECAUTIONS TO PREVENT SEDIMENT FROM LEAVING THE SITE.
- 16. CONSTRUCTION VEHICLES SHALL UTILIZE THE STABILIZED CONSTRUCTION ENTRANCE TO THE EXTENT POSSIBLE THROUGHOUT CONSTRUCTION.
- 17. IF INSTALLATION OF STORM DRAINAGE SYSTEM SHOULD BE INTERRUPTED BY WEATHER OR NIGHTFALL, THE PIPE ENDS SHALL BE COVERED WITH FILTER FABRIC.
- 18. THE GENERAL CONTRACTOR SHALL BE RESPONSIBLE TO TAKE WHATEVER MEANS NECESSARY TO ESTABLISH PERMANENT SOIL
- 19. SEDIMENT SHALL BE REMOVED FROM ALL SEDIMENT BASINS BEFORE THEY ARE 25% FULL.
- 20. ALL WORK SHALL BE DONE IN STRICT ACCORDANCE WITH PROJECT SPECIFICATIONS.
- 21. ADDITIONAL EROSION AND SEDIMENT CONTROL MEASURES SHALL BE INSTALLED, IF DEEMED NECESSARY BY ON-SITE INSPECTION BY ENGINEER AND/OR REGULATORY OFFICIALS.
- 22. SEE ALSO EROSION AND SEDIMENT CONTROL SPECIFICATIONS ON SHEET E1.


PROJECT PARCEL TOWN OF EPPING TAX MAP 35, LOT 26-2 BK 5976, PG 1989

TOTAL LOT AREA 130,849 SQ. FT. 3.00 ACRES

Project No.: 14161.3 Checked: JAC | Scale: 1"=40' Drawing Name: 14161-PLAN-LOT26-2.dwg THIS PLAN SHALL NOT BE MODIFIED WITHOUT WRITTEN PERMISSION FROM JONES & BEACH ENGINEERS, INC. (JBE).

ANY ALTERATIONS, AUTHORIZED OR OTHERWISE, SHALL BE

T THE USER'S SOLE RISK AND WITHOUT LIABILITY TO JBE.

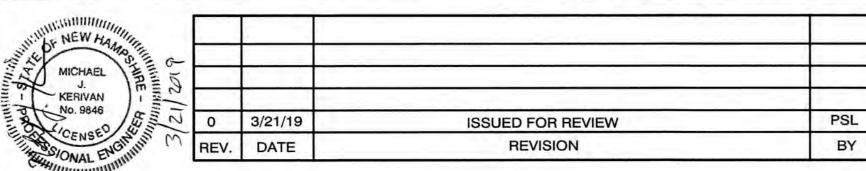

Designed and Produced in NH Jones & Beach Engineers, Inc. 85 Portsmouth Ave. Civil Engineering Services
PO Box 219 603-772-4746

Stratham, NH 03885

GRADING, DRAINAGE & UTILITY PLAN

NEW ENGLAND PAVING ASPHALT PLANT 30 SHIRKING ROAD, EPPING, NH Project: SAM PATTERSON REAL ESTATE DEV., LLC PO BOX 2793, SEABROOK, NH 03874 Owner of Record:

GRAPHIC SCALE

(IN FEET)

1 inch = 40 ft.

BERM ELEV. 195.0

- WET POND (UNDER

CONSTRUCTION) TO BE EXTENDED APPROX. 50'

·YET INSTALLED) -

- MULTI STAGE DISCHARGE

OUTLET STRUCTURE (NOT


ORIFICES TO BE MODIFIED

FROM ORIGINAL DESIGN

(SEE NEW DETAIL SHEET

C3SHEET 4 OF 7 JBE PROJECT NO. 14161.3

DRAWING No.

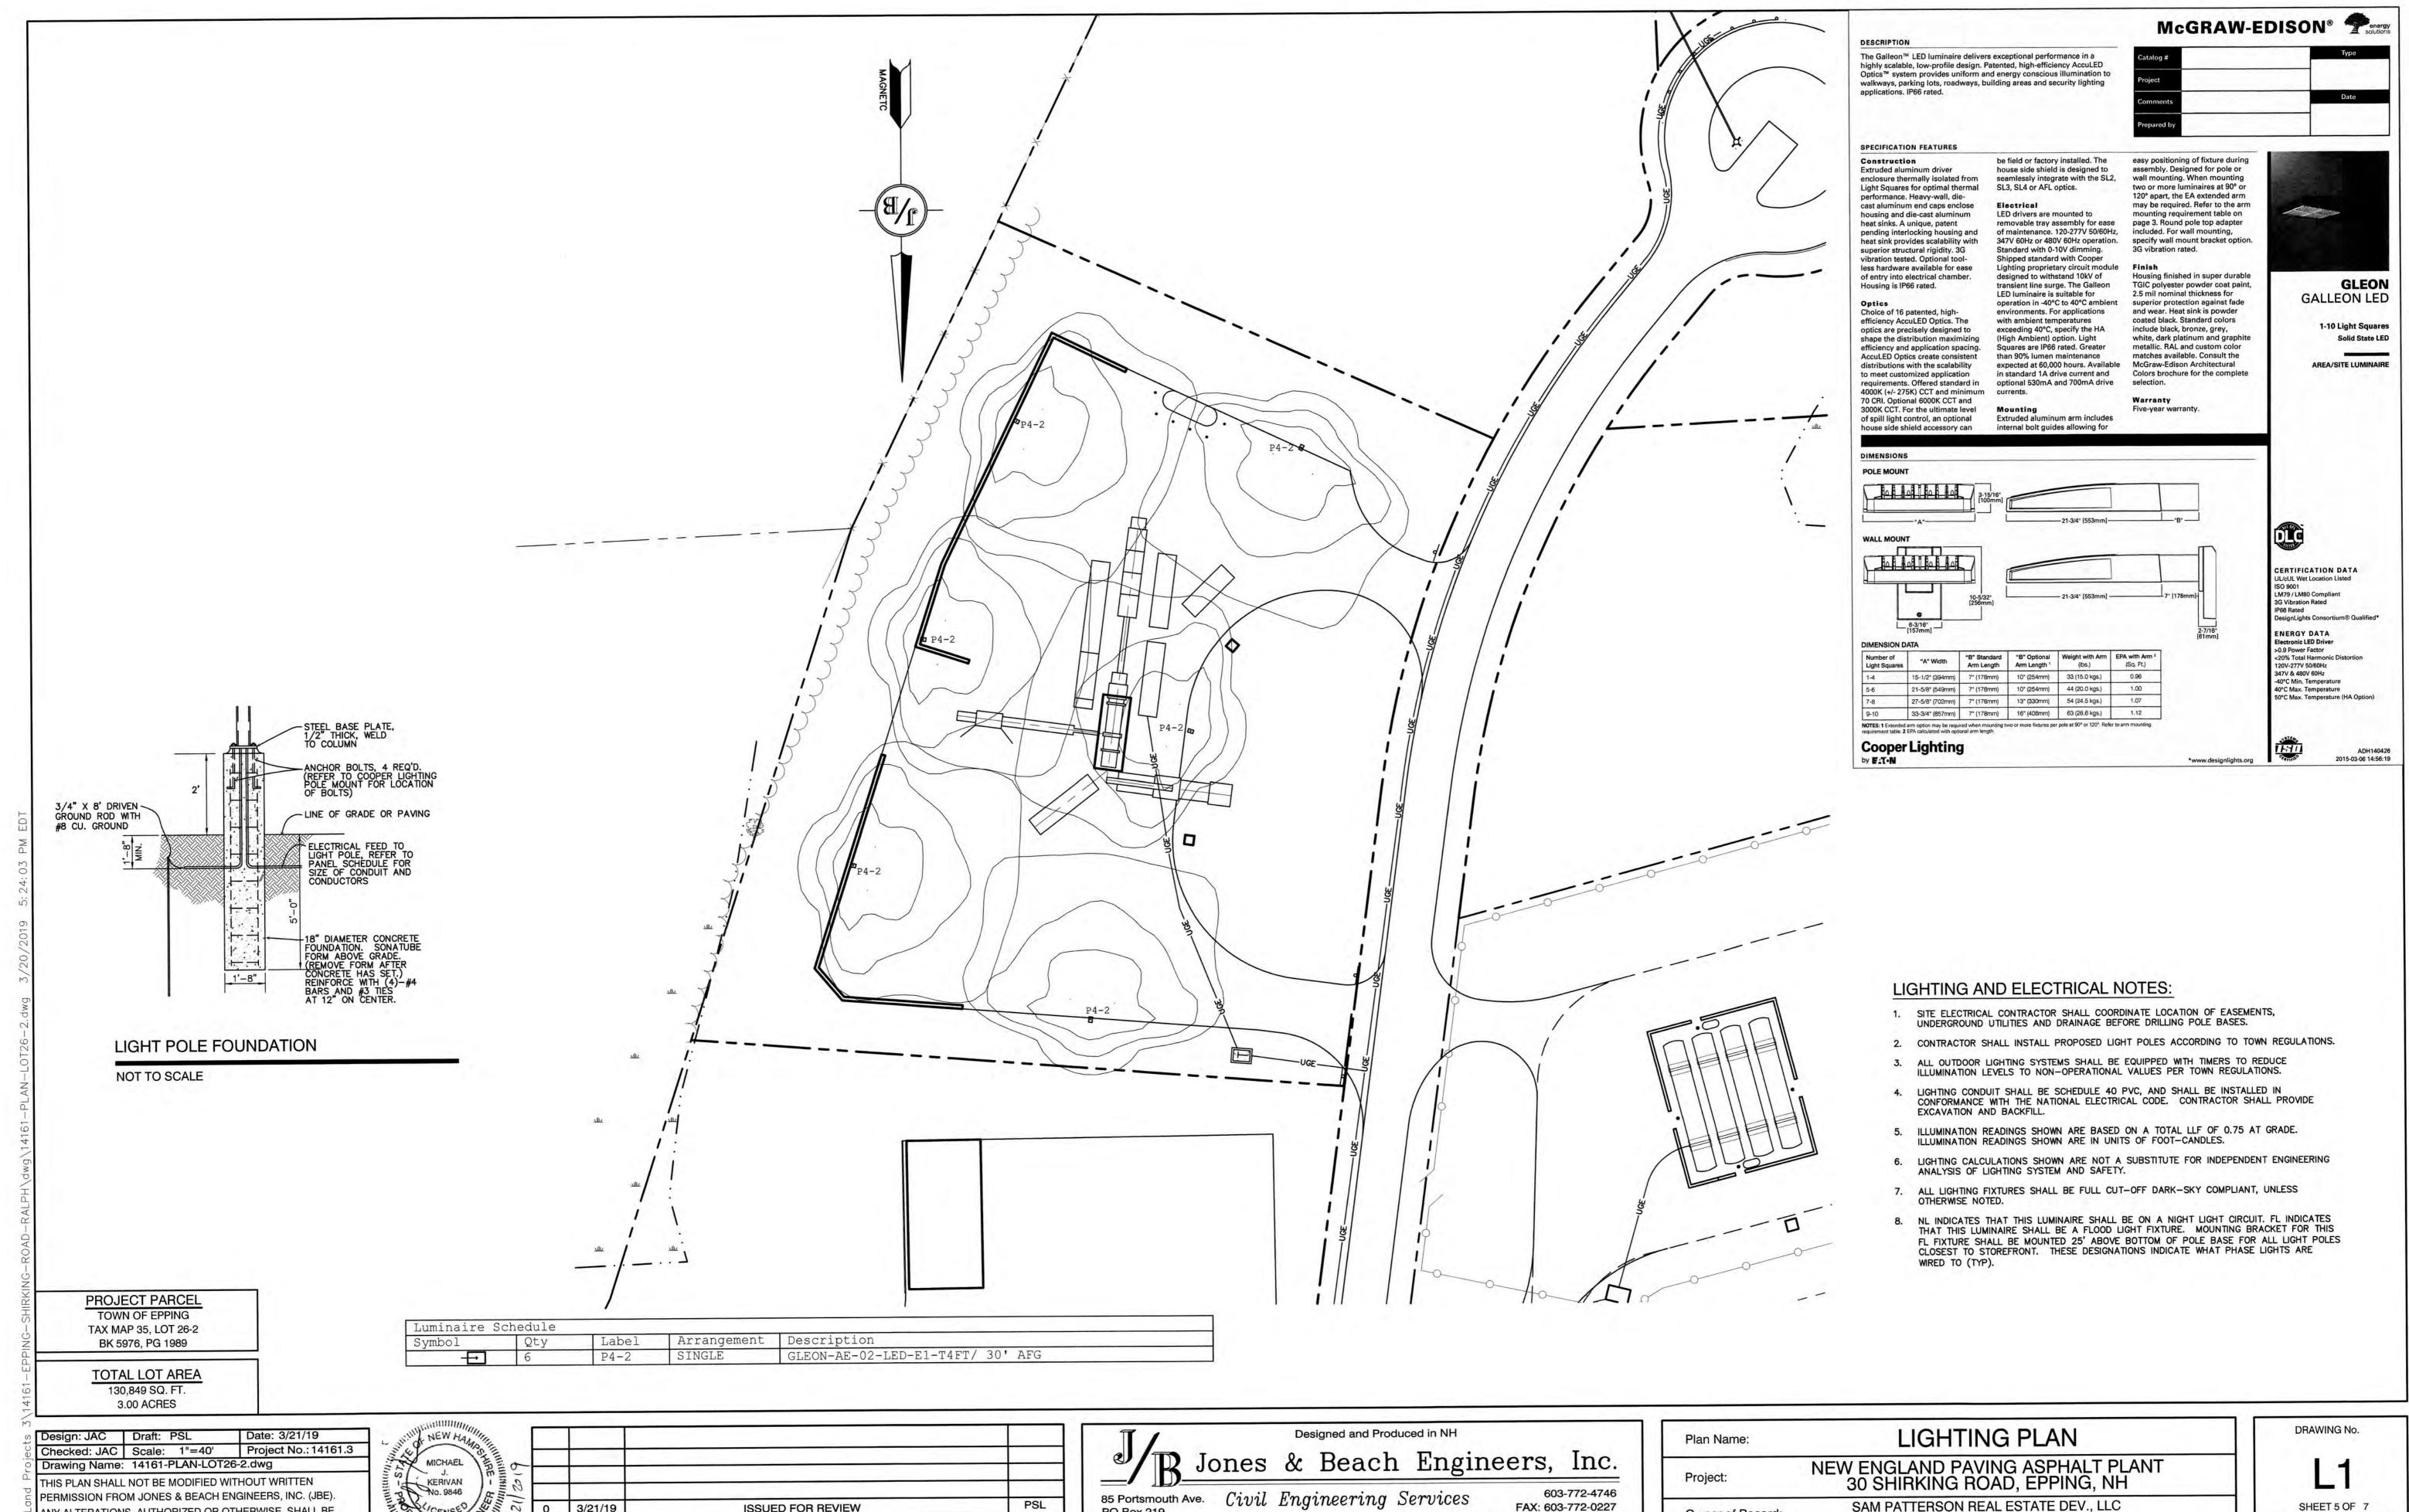

PO Box 219

Stratham, NH 03885

ISSUED FOR REVIEW

REVISION

0 3/21/19

REV. DATE

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AT THE USER'S SOLE RISK AND WITHOUT LIABILITY TO JBE.

FAX: 603-772-0227

E-MAIL: JBE@JONESANDBEACH.COM


Owner of Record:

PO BOX 2793, SEABROOK, NH 03874

SHEET 5 OF 7 JBE PROJECT NO. 14161.3 NOTE: ALL UTILITIES SHALL BE REVIEWED AND APPROVED BY APPROPRIATE UTILITY COMPANY.

UTILITY TRENCH

NOT TO SCALE

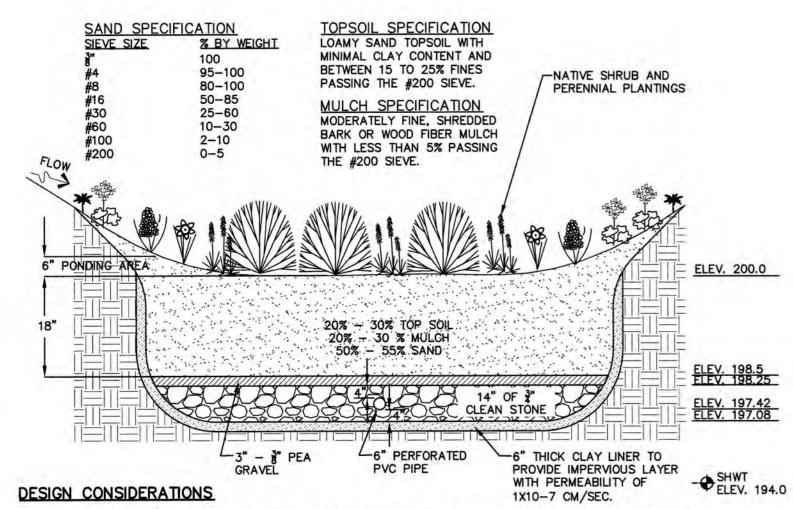


- DO NOT PLACE BIORETENTION SYSTEMS INTO SERVICE UNTIL THE BMP HAS BEEN PLANTED AND ITS CONTRIBUTING AREAS HAVE BEEN FULLY STABILIZED.
- DO NOT DISCHARGE SEDIMENT-LADEN WATERS FROM CONSTRUCTION ACTIVITIES (RUN-OFF, WATER FROM EXCAVATIONS) TO THE BIORETENTION AREA DURING ANY STAGE OF CONSTRUCTION.
- DO NOT TRAFFIC EXPOSED SOIL SURFACE WITH CONSTRUCTION EQUIPMENT. IF FEASIBLE, PERFORM EXCAVATIONS WITH EQUIPMENT OUTSIDE THE LIMITS OF THE INFILTRATION COMPONENTS OF THE

MAINTENANCE REQUIREMENTS:

- SYSTEMS SHOULD BE INSPECTED AT LEAST TWICE ANNUALLY, AND FOLLOWING ANY RAINFALL EVENT EXCEEDING 2.5 INCHES IN A 24 HOUR PERIOD, WITH MAINTENANCE OR REHABILITATION CONDUCTED AS WARRANTED BY SUCH INSPECTION.
- PRETREATMENT MEASURES SHOULD BE INSPECTED AT LEAST TWICE ANNUALLY, AND CLEANED OF ACCUMULATED SEDIMENT AS WARRANTED BY INSPECTION, BUT NO LESS THAN ONCE ANNUALLY.
- 3. TRASH AND DEBRIS SHOULD BE REMOVED AT EACH INSPECTION.
- 4. AT LEAST ONCE ANNUALLY, SYSTEM SHOULD BE INSPECTED FOR DRAWDOWN TIME. IF BIORETENTION SYSTEM DOES NOT DRAIN WITHIN 72 HOURS FOLLOWING A RAINFALL EVENT, THEN A QUALIFIED PROFESSIONAL SHOULD ASSESS THE CONDITION OF THE FACILITY TO DETERMINE MEASURES REQUIRED TO RESTORE FILTRATION FUNCTION OR INFILTRATION FUNCTION (AS APPLICABLE), INCLUDING BUT NOT LIMITED TO REMOVAL OF ACCUMULATED SEDIMENTS OR RECONSTRUCTION OF THE FILTER MEDIA.
- VEGETATION SHOULD BE INSPECTED AT LEAST ANNUALLY, AND MAINTAINED IN HEALTHY CONDITION, INCLUDING PRUNING, REMOVAL AND REPLACEMENT OF DEAD OR DISEASED VEGETATION, AND REMOVAL
- CLAY LINER MATERIAL SHALL BE CLEAN SILTY-CLAY BORROW FREE OF ROOTS, ORGANIC MATTER, AND OTHER DELETERIOUS SUBSTANCES, AND SHALL CONTAIN NO ROCKS OR LUMPS OVER THREE INCHES (3") IN DIAMETER. THIS MATERIAL SHALL BE INSTALLED IN 6" LIFTS COMPACTED TO 92% OF ASTM D-1557, AND SHALL MEET THE FOLLOWING SPECIFICATIONS: 6" PASSING 100%, #4 SIEVE 95-100%, #40 SIEVE 60-90%, #100 SIEVE 40-60%, #200 SIEVE 25-45% (OF THE FRACTION PASSING THE #4 SIEVE). THE CLAY COMPONENT SHALL HAVE A PLASTICITY INDEX OF AT LEAST 8 AND A HYDRAULIC CONDUCTIVITY OF 10 TO THE -6 CM/SEC.
- COMPACTION AND MATERIALS TESTING SERVICES SHALL BE PERFORMED BY AN INDEPENDENT GEOTECHNICAL ENGINEER RETAINED BY THE OWNER.


NOT TO SCALE

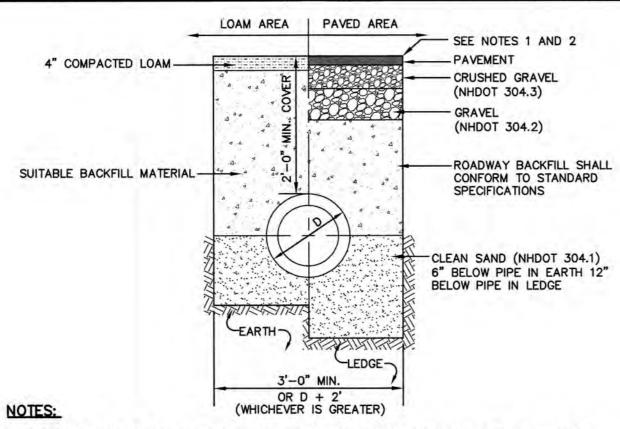

- 1. PAVEMENT REPAIR IN EXISTING ROADWAYS SHALL CONFORM TO STREET OPENING REGULATIONS.
- 2. NEW ROADWAY CONSTRUCTION SHALL CONFORM WITH PROJECT AND TOWN SPECIFICATIONS.
- 3. ALL MATERIALS ARE TO BE COMPACTED TO 95% OF ASTM D-1557.


DRAINAGE TRENCH

NOT TO SCALE

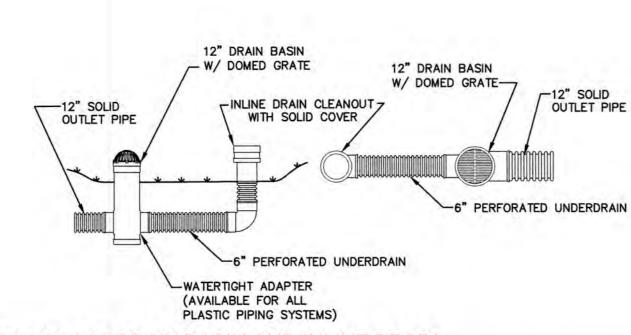


NYOPLAST DRAIN BASIN AND INLINE DRAIN

NOT TO SCALE

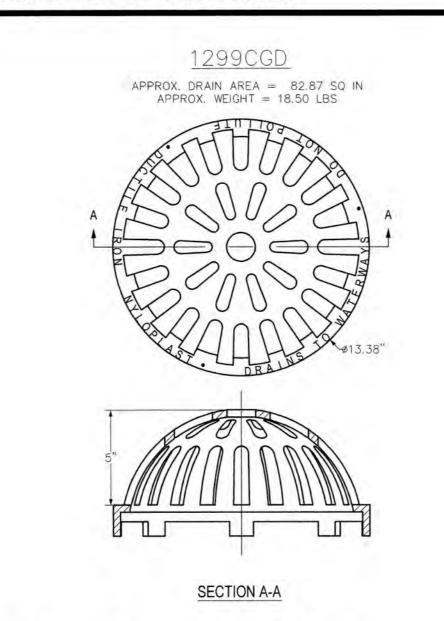

- 1. DIMENSIONS ARE FOR REFERENCE ONLY, ACTUAL DIMENSIONS MAY VARY.
- 2. MATERIALS SHALL CONFORM TO ASTM A536 GRADE 70-50-05.
- 3. CASTINGS ARE FURNISHED WITH A BLACK PAINT.
- 4. LOCKING DEVICE AVAILABLE UPON REQUEST 12' NYOPLAST DOME GRATE

NOT TO SCALE

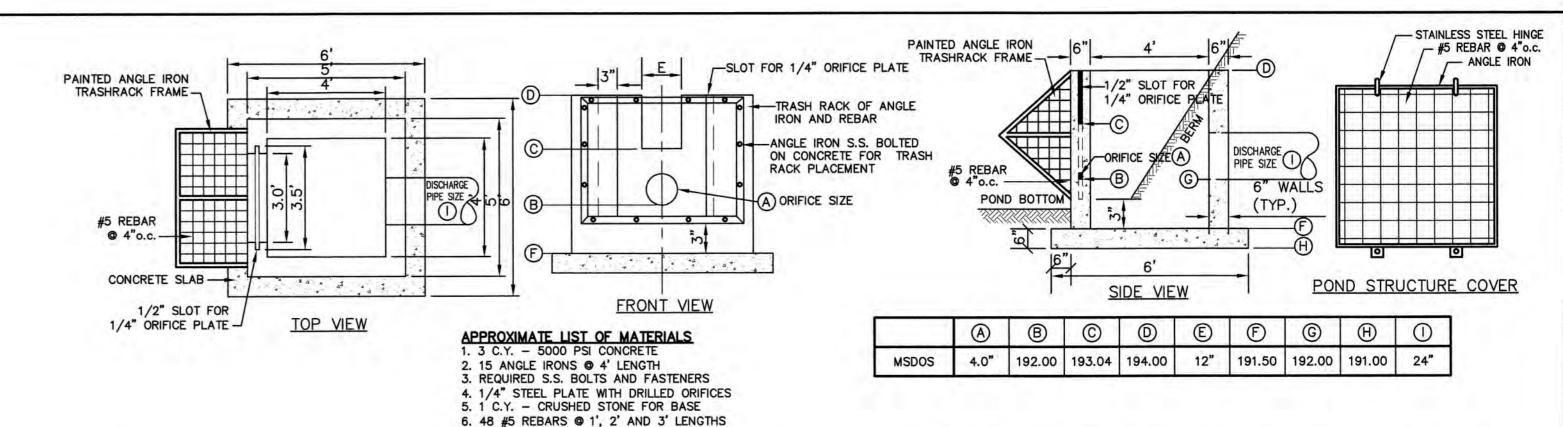


NOTES:


1. REINFORCING STEEL SHALL CONSIST OF A SINGLE LAYER OF HORIZONTAL AND VERTICAL PLACED #4 REBAR ©

7. 32 #4 REBARS @ 4.5' LENGTH

- CONCRETE BOX TO BE CONSTRUCTED OR PRECAST OF EQUAL DIMENSIONS AND REINFORCING. CONCRETE SLAB TO BE CONSTRUCTED ALONG WITH BASE. FOR PRECAST BOX, A SLOTTED CONCRETE SLAB TO
- BE USED.
- 4. SECTION JOINTS AND PIPE OPENING SHALL BE SEALED WATERTIGHT WITH MORTAR BY CONTRACTOR.
- 5. ALL EXPOSED REBAR TO BE PAINTED WITH RUST-RESISTANT PAINT, COLOR AT CONTRACTOR'S DISCRETION. TO BE SUPPLIED BY CAPITAL CONCRETE PRODUCTS OF HENNIKER, N.H., (1-603-428-3218) OR EQUAL.
- STRUCTURE TO HAVE TEMPORARY PLYWOOD INSTALLED IN THE ORIFICE PLATE SLOT UNTIL THE SITE IS
- STRUCTURE IS TO BE DESIGNED FOR H20 LOADING. SOIL UNDERLYING THE STRUCTURE IS TO BE COMPACTED TO 95% MODIFIED PROCTOR.

MULTI-STAGE DISCHARGE OUTLET STRUCTURE (MSDOS)

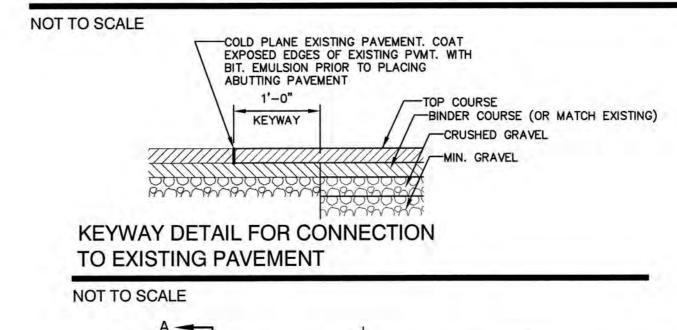

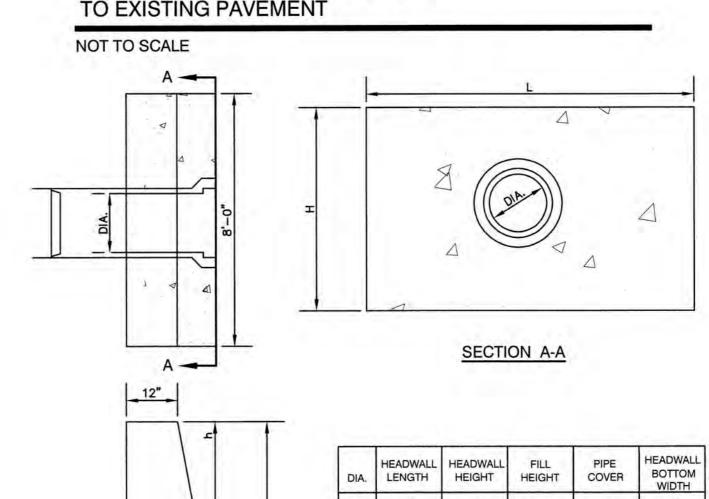

	DIA.	HEADWALL LENGTH	HEADWALL HEIGHT	FILL HEIGHT	
	D	Ĺ	н	FH	T
	12"	4'-2"	3'-9"	1'-6"	T
\ <u></u>	15"	5'-11"	4'-2"	1'-6"	Ť
	18"	6'-11"	4'-5"	1'-6"	İ
	24"	8'-10"	4'-11"	1'-6"	T

1'-3"

1'-5"

1'-5"

1'-5"

1'-11"

2'-0"

2'-1"

NOTES:


ALL DIMENSIONS GIVEN IN FEET & INCHES.

LONGITUDINAL SECTION


- PROVIDE BELL END AT INLET HEADWALL, AND SPIGOT END AT OUTLET END HEADWALL. 3. CONCRETE: 5,000 PSI MINIMUM AFTER 28 DAYS. CEMENT TO BE TYPE III PER ASTM
- C-150. REINFORCING TO MEET OR EXCEED ASTM A-615 GRADE 60 DEFORMED BARS. 4. 1" THREADED INSERTS PROVED FOR FINAL ATTACHMENT IN FIELD BY OTHERS.

PRECAST CONCRETE HEADWALL

NOT TO SCALE

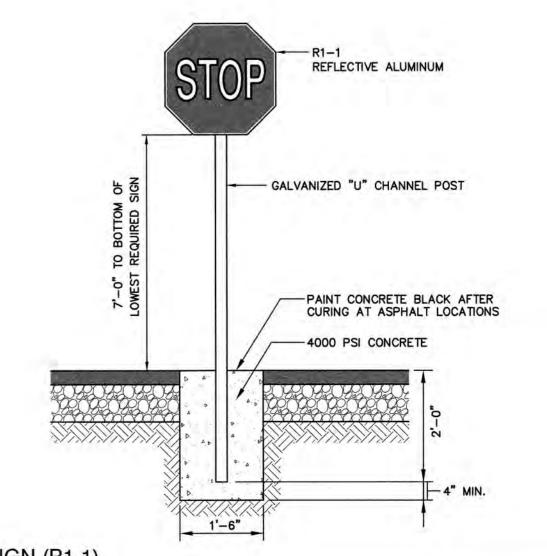

STOP SIGN (R1-1)

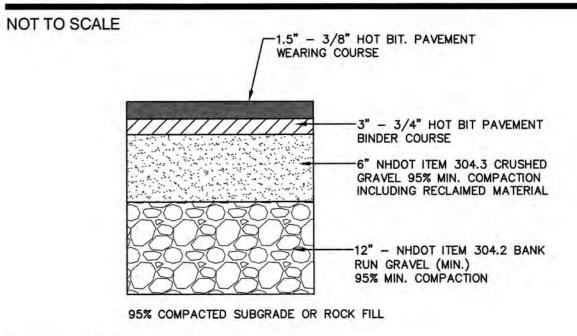

TYPICAL BITUMINOUS PAVEMENT

PO BOX 2793, SEABROOK, NH 03874

NOT TO SCALE

BIORETENTION SYSTEM (with clay bottom and pipe)

Design: JAC Draft: PSL Date: 3/21/19 Checked: JAC | Scale: AS NOTED | Project No.: 14161.3 Drawing Name: 14161-PLAN-LOT26-2.dwg THIS PLAN SHALL NOT BE MODIFIED WITHOUT WRITTEN PERMISSION FROM JONES & BEACH ENGINEERS, INC. (JBE).

ANY ALTERATIONS, AUTHORIZED OR OTHERWISE, SHALL BE

AT THE USER'S SOLE RISK AND WITHOUT LIABILITY TO JBE.



0	3/21/19	ISSUED FOR REVIEW	PSL
REV.	DATE	REVISION	BY

Designed and Produced in NH

85 Portsmouth Ave. Civil Engineering Services PO Box 219

Stratham, NH 03885


Beach	Engin	eers,	Inc.
neering S	Services		3-772-4746 3-772-0227


E-MAIL: JBE@JONESANDBEACH.COM

Plan Name:	DETAIL SHEET
Project:	NEW ENGLAND PAVING ASPHALT PLANT 30 SHIRKING ROAD, EPPING, NH
Owner of Record:	SAM PATTERSON REAL ESTATE DEV., LLC

DRAWING No. SHEET 6 OF 7 JBE PROJECT NO. 14161.3

- EROSION, SEDIMENT AND DETENTION MEASURES SHALL BE INSTALLED AS SHOWN ON THE PLANS AND AT LOCATIONS AS REQUIRED, DIRECTED BY THE ENGINEER.
- ALL DISTURBED AREAS (INCLUDING POND AREAS BELOW THE PROPOSED WATERLINE) SHALL BE RETURNED TO PROPOSED GRADES AND ELEVATIONS. DISTURBED AREAS SHALL BE LOAMED WITH A MINIMUM OF 6" OF SCREENED ORGANIC LOAM AND SEEDED WITH SEED MIXTURE 'C' AT A RATE NOT LESS THAN 1.10 POUNDS OF SEED PER 1,000 S.F. OF AREA (48 LBS. / ACRE).
- SILT FENCES AND OTHER BARRIERS SHALL BE INSPECTED EVERY SEVEN CALENDAR DAYS AND WITHIN 24 HOURS OF A RAINFALL OF 0.25" OR GREATER. ALL DAMAGED AREAS SHALL BE REPAIRED, AND SEDIMENT DEPOSITS SHALL PERIODICALLY BE REMOVED AND DISPOSED OF.
- AFTER ALL DISTURBED AREAS HAVE BEEN STABILIZED, THE TEMPORARY EROSION CONTROL MEASURES SHALL BE REMOVED AND THE AREA DISTURBED BY THE REMOVAL SMOOTHED AND RE-VEGETATED.
- AREAS MUST BE SEEDED AND MULCHED OR OTHERWISE PERMANENTLY STABILIZED WITHIN 3 DAYS OF FINAL GRADING, OR TEMPORARILY STABILIZED WITHIN 14 DAYS OF THE INITIAL DISTURBANCE OF SOIL. ALL AREAS SHALL BE STABILIZED WITHIN 45 DAYS OF INITIAL DISTURBANCE.
- ALL PROPOSED VEGETATED AREAS THAT DO NOT EXHIBIT A MINIMUM OF 85 PERCENT VEGETATIVE GROWTH BY OCTOBER 15, OR WHICH ARE DISTURBED AFTER OCTOBER 15, SHALL BE STABILIZED BY SEEDING AND INSTALLING NORTH AMERICAN GREEN S75 EROSION CONTROL BLANKETS (OR AN EQUIVALENT APPROVED IN WRITING BY THE ENGINEER) ON SLOPES GREATER THAN 3:1, AND SEEDING AND PLACING 3 TO 4 TONS OF MULCH PER ACRE, SECURED WITH ANCHORED NETTING, ELSEWHERE. THE INSTALLATION OF EROSION CONTROL BLANKETS OR MULCH AND NETTING SHALL NOT OCCUR OVER ACCUMULATED SNOW OR ON FROZEN GROUND AND SHALL BE COMPLETED IN ADVANCE OF THAW OR SPRING MELT EVENTS.
- ALL DITCHES OR SWALES WHICH DO NOT EXHIBIT A MINIMUM OF 85 PERCENT VEGETATIVE GROWTH BY OCTOBER 15, OR WHICH ARE DISTURBED AFTER OCTOBER 15, SHALL BE STABILIZED TEMPORARILY WITH STONE OR EROSION CONTROL BLANKETS APPROPRIATE FOR THE DESIGN FLOW CONDITIONS.
- AFTER NOVEMBER 15th, INCOMPLETE ROAD OR PARKING SURFACES, WHERE WORK HAS STOPPED FOR THE WINTER SEASON, SHALL BE PROTECTED WITH A MINIMUM OF 3" OF CRUSHED GRAVEL PER NHDOT ITEM 304.3.
- AN AREA SHALL BE CONSIDERED STABLE IF ONE OF THE FOLLOWING HAS OCCURRED:
 - BASE COURSE GRAVELS HAVE BEEN INSTALLED IN AREAS TO BE PAVED;
 - b. A MINIMUM OF 85% VEGETATED GROWTH HAS BEEN ESTABLISHED;
 - c. A MINIMUM OF 3" OF NON-EROSIVE MATERIAL SUCH STONE OR RIPRAP HAS BEEN INSTALLED; OR
- d. EROSION CONTROL BLANKETS HAVE BEEN PROPERLY INSTALLED
- . FUGITIVE DUST CONTROL IS REQUIRED TO BE CONTROLLED IN ACCORDANCE WITH ENV-A 1000, AND THE PROJECT IS TO MEET. THE REQUIREMENTS AND INTENT OF RSA 430:53 AND AGR 3800 RELATIVE TO INVASIVE SPECIES.
- 12. PRIOR TO BEGINNING CONSTRUCTION, THE CONTRACTOR'S NAME, ADDRESS, AND PHONE NUMBER SHALL BE SUBMITTED TO DES VIA EMAIL (SEE BELOW).
- PRIOR TO CONSTRUCTION, A PHASING PLAN THAT DELINEATES EACH PHASE OF THE PROJECT SHALL BE SUBMITTED. ALL TEMPORARY SEDIMENT BASINS THAT WILL BE NEEDED FOR DEWATERING WORK AREAS SHALL BE LOCATED AND IDENTIFIED ON THIS PLAN.
- I. IN ORDER TO ENSURE THE STABILITY OF THE SITE AND EFFECTIVE IMPLEMENTATION OF THE SEDIMENT AND EROSION CONTROL MEASURES SPECIFIED IN THE PLANS FOR THE DURATION OF CONSTRUCTION, THE CONTRACTOR SHALL BE IN STRICT COMPLIANCE WITH THE FOLLOWING INSPECTION AND MAINTENANCE REQUIREMENTS IN ADDITION TO THOSE CALLED FOR IN THE SWPPP:
 - a. A CERTIFIED PROFESSIONAL IN EROSION AND SEDIMENT CONTROL OR A PROFESSIONAL ENGINEER LICENSED IN THE STATE OF NEW HAMPSHIRE ("MONITOR") SHALL BE EMPLOYED TO INSPECT THE SITE FROM THE START OF ALTERATION OF TERRAIN ACTIVITIES UNTIL THE SITE IS IN FULL COMPLIANCE WITH THE SITE SPECIFIC PERMIT ("PERMIT").
 - b. DURING THIS PERIOD, THE MONITOR SHALL INSPECT THE SUBJECT SITE AT LEAST ONCE A WEEK, AND IF POSSIBLE, DURING ANY 1/2 INCH OR GREATER RAIN EVENT (I.E. 1/2 INCH OF PRECIPITATION OR MORE WITHIN A 24 HOUR PERIOD). IF UNABLE TO BE PRESENT DURING SUCH A STORM, THE MONITOR SHALL INSPECT THE SITE WITHIN 24 HOURS OF THIS EVENT.
 - THE MONITOR SHALL PROVIDE TECHNICAL ASSISTANCE AND RECOMMENDATIONS TO THE CONTRACTOR ON THE APPROPRIATE BEST MANAGEMENT PRACTICES FOR EROSION AND SEDIMENT CONTROLS REQUIRED TO MEET THE REQUIREMENTS OF RSA 485 A:17 AND ALL APPLICABLE DES PERMIT CONDITIONS.
 - d. WITHIN 24 HOURS OF EACH INSPECTION, THE MONITOR SHALL SUBMIT A REPORT TO DES VIA EMAIL (RIDGELY MAUCK AT: RIDGELY.MAUCK@DES.NH.GOV).
 - e. THE MONITOR SHALL MEET WITH DES TO DECIDE UPON A REPORT FORMAT. THE REPORT FORMAT SHALL BE REVIEWED AND APPROVED BY DES PRIOR TO THE START OF CONSTRUCTION.

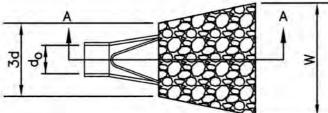

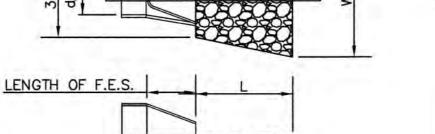





SECTION A-A PIPE OUTLET TO FLAT AREA WITH NO DEFINED CHANNEL


SECTION A-A PIPE OUTLET TO WELL-DEFINED CHANNEL

TABLE 7-24R	ECOMMENDED	RIP RAP G	RADAT	TON RANGES
THICKNESS OF R	IP RAP = 1.	5 FEET		
d50 SIZE=	0.25	FEET	3	INCHES
% OF WEIGHT SM THAN THE GIVEN		SIZE C	F STO	NE (INCHES) TO
100%		5		6
85%		4		5
50%		3		5
15%		1		2

- 1. THE SUBGRADE FOR THE GEOTEXTILE FABRIC AND RIP RAP SHALL BE PREPARED TO THE LINES AND GRADES SHOWN ON THE PLANS.
- 2. THE RIP RAP SHALL CONFORM TO THE SPECIFIED GRADATION.
- 3. GEOTEXTILE FABRICS SHALL BE PROTECTED FROM PUNCTURE OR TEARING DURING THE PLACEMENT OF THE ROCK RIP. DAMAGED AREAS IN THE FABRIC SHALL BE REPAIRED BY PLACING A PIECE OF FABRIC OVER THE DAMAGED AREA OR BY COMPLETE REPLACEMENT OF THE FABRIC. ALL OVERLAPS REQUIRED FOR REPAIRS OR JOINING TWO PIECES OF FABRIC SHALL BE A MINIMUM OF 12 INCHES.
- 4. STONE FOR THE RIP RAP MAY BE PLACED BY EQUIPMENT AND SHALL BE CONSTRUCTED TO THE FULL LAYER THICKNESS IN ONE OPERATION AND IN SUCH A MANNER AS TO PREVENT SEGREGATION OF THE
- 5. OUTLETS TO A DEFINED CHANNEL SHALL HAVE 2:1 OR FLATTER SIDE SLOPES AND SHOULD BEGIN AT THE TOP OF THE CULVERT AND TAPER DOWN TO THE CHANNEL BOTTOM THROUGH THE LENGTH OF THE
- 6. MAINTENANCE: THE OUTLET PROTECTION SHOULD BE CHECKED AT LEAST ANNUALLY AND AFTER EVERY MAJOR STORM. IF THE RIP RAP HAS BEEN DISPLACED, UNDERMINED OR DAMAGED, IT SHOULD BE REPAIRED IMMEDIATELY. THE CHANNEL IMMEDIATELY BELOW THE OUTLET SHOULD BE CHECKED TO SEE THAT EROSION IS NOT OCCURRING. THE DOWNSTREAM CHANNEL SHOULD BE KEPT CLEAR OF OBSTRUCTIONS SUCH AS FALLEN TREES, DEBRIS, AND SEDIMENT THAT COULD CHANGE FLOW PATTERNS AND/OR TAILWATER DEPTHS ON THE PIPES, REPAIRS MUST BE CARRIED OUT IMMEDIATELY TO AVOID ADDITIONAL DAMAGE TO OUTLET PROTECTION.

RIP RAP OUTLET PROTECTION APRON

NOT TO SCALE

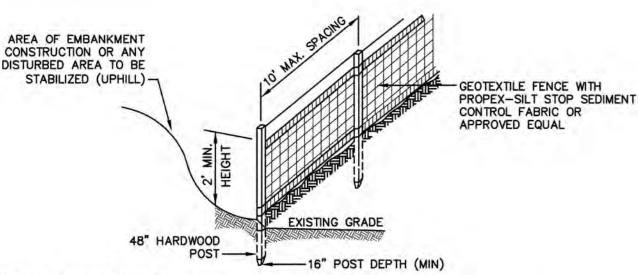

CONSTRUCTION SPECIFICATIONS:


- WOVEN FABRIC FENCE TO BE FASTENED SECURELY TO FENCE POSTS WITH WIRE TIES OR STAPLES. FILTER CLOTH SHALL BE FASTENED TO WOVEN WIRE EVERY 24" AT TOP, MID AND BOTTOM AND EMBEDDED IN THE GROUND A MINIMUM OF 8" AND THEN COVERED WITH SOIL.
- THE FENCE POSTS SHALL BE A MINIMUM OF 48" LONG, SPACED A MAXIMUM 10' APART, AND DRIVEN A MINIMUM OF 16" INTO THE GROUND.
- , WHEN TWO SECTIONS OF FILTER CLOTH ADJOIN EACH OTHER, THE ENDS OF THE FABRIC SHALL BE OVERLAPPED 6", FOLDED AND STAPLED TO PREVENT SEDIMENT FROM BY-PASSING.
- 4. MAINTENANCE SHALL BE PERFORMED AS NEEDED AND SEDIMENT REMOVED AND PROPERLY DISPOSED OF WHEN IT IS 6" DEEP OR VISIBLE 'BULGES' DEVELOP IN THE SILT FENCE.

5. PLACE THE ENDS OF THE SILT FENCE UP CONTOUR TO PROVIDE FOR SEDIMENT STORAGE.

NOT TO SCALE

Design: JAC | Draft: PSL

SILT FENCE

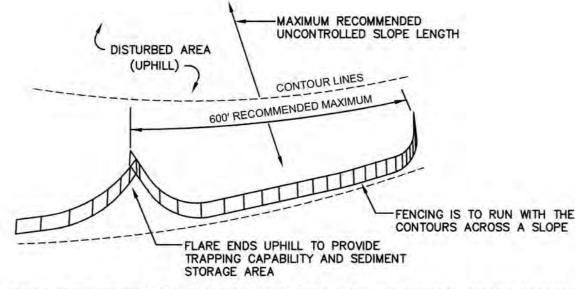

6. SILT FENCES SHALL BE REMOVED WHEN NO LONGER NEEDED AND THE SEDIMENT COLLECTED SHALL BE DISPOSED AS DIRECTED BY THE ENGINEER. THE AREA DISTURBED BY THE REMOVAL SHALL BE SMOOTHED AND REVEGETATED.

MAINTENANCE:

- 1. SILT FENCES SHALL BE INSPECTED IMMEDIATELY AFTER EACH RAINFALL AND AT LEAST DAILY DURING PROLONGED RAINFALL. ANY REPAIRS THAT ARE REQUIRED SHALL BE DONE IMMEDIATELY.
- 2. IF THE FABRIC ON A SILT FENCE SHOULD DECOMPOSE OR BECOME INEFFECTIVE DURING THE EXPECTED LIFE OF THE FENCE, THE FABRIC SHALL BE REPLACED PROMPTLY.
- 3. SEDIMENT DEPOSITS SHOULD BE INSPECTED AFTER EVERY STORM EVENT. THE DEPOSITS SHOULD BE REMOVED WHEN THEY REACH APPROXIMATELY ONE HALF THE HEIGHT OF THE BARRIER.
- 4. SEDIMENT DEPOSITS THAT ARE REMOVED, OR LEFT IN PLACE AFTER THE FABRIC HAS BEEN REMOVED, SHALL BE GRADED TO CONFORM WITH THE EXISTING TOPOGRAPHY AND VEGETATED.

PO Box 219

Stratham, NH 03885

SEEDING SPECIFICATIONS

- 1. GRADING AND SHAPING A. SLOPES SHALL NOT BE STEEPER THAN 2:1 WITHOUT APPROPRIATE EROSION CONTROL MEASURES AS
- SPECIFIED ON THE PLANS (3:1 SLOPES OR FLATTER ARE PREFERRED). B. WHERE MOWING WILL BE DONE, 3:1 SLOPES OR FLATTER ARE RECOMMENDED.

2. SEEDBED PREPARATION

- A. SURFACE AND SEEPAGE WATER SHOULD BE DRAINED OR DIVERTED FROM THE SITE TO PREVENT DROWNING OR WINTER KILLING OF THE PLANTS.
- STONES LARGER THAN 4 INCHES AND TRASH SHOULD BE REMOVED BECAUSE THEY INTERFERE WITH SEEDING AND FUTURE MAINTENANCE OF THE AREA. WHERE FEASIBLE, THE SOIL SHOULD BE TILLED TO A DEPTH OF ABOUT 4 INCHES TO PREPARE A SEEDBED AND FERTILIZER AND LIME MIXED INTO THE SOIL. THE SEEDBED SHOULD BE LEFT IN A REASONABLY FIRM AND SMOOTH CONDITION. THE LAST TILLAGE OPERATION SHOULD BE PERFORMED ACROSS THE SLOPE WHEREVER PRACTICAL.

3. ESTABLISHING A STAND

- A. LIME AND FERTILIZER SHOULD BE APPLIED PRIOR TO OR AT THE TIME OF SEEDING AND INCORPORATED INTO THE SOIL. TYPES AND AMOUNTS OF LIME AND FERTILIZER SHOULD BE BASED ON AN EVALUATION OF SOIL TESTS. WHEN A SOIL TEST IS NOT AVAILABLE, THE FOLLOWING MINIMUM AMOUNTS SHOULD BE
- AGRICULTURAL LIMESTONE, 2 TONS PER ACRE OR 100 LBS. PER 1,000 SQ.FT.
- NITROGEN(N), 50 LBS. PER ACRE OR 1.1 LBS. PER 1,000 SQ.FT. PHOSPHATE(P205), 100 LBS. PER ACRE OR 2.2 LBS. PER 1,000 SQ.FT.
- POTASH(K2O), 100 LBS. PER ACRE OR 2.2 LBS. PER 1,000 SQ.FT. (NOTE: THIS IS THE EQUIVALENT OF 500 LBS. PER ACRE OF 10-20-20 FERTILIZER OR 1,000 LBS. PER
- ACRE OF 5-10-10.) SEED SHOULD BE SPREAD UNIFORMLY BY THE METHOD MOST APPROPRIATE FOR THE SITE. METHODS INCLUDE BROADCASTING, DRILLING AND HYDROSEEDING. WHERE BROADCASTING IS USED, COVER SEED WITH
- .25 INCH OF SOIL OR LESS, BY CULTIPACKING OR RAKING. C. REFER TO THE 'SEEDING GUIDE' AND 'SEEDING RATES' TABLES ON THIS SHEET FOR APPROPRIATE SEED MIXTURES AND RATES OF SEEDING. ALL LEGUMES (CROWNVETCH, BIRDSFOOT, TREFOIL AND FLATPEA)

MUST BE INOCULATED WITH THEIR SPECIFIC INOCULANT PRIOR TO THEIR INTRODUCTION TO THE SITE.

WHEN SEEDED AREAS ARE MULCHED, PLANTINGS MAY BE MADE FROM EARLY SPRING TO EARLY OCTOBER. WHEN SEEDED AREAS ARE NOT MULCHED, PLANTINGS SHOULD BE MADE FROM EARLY SPRING TO MAY 20th OR FROM AUGUST 10th TO SEPTEMBER 1st.

A. HAY, STRAW, OR OTHER MULCH, WHEN NEEDED, SHOULD BE APPLIED IMMEDIATELY AFTER SEEDING. B. MULCH WILL BE HELD IN PLACE USING APPROPRIATE TECHNIQUES FROM THE BEST MANAGEMENT PRACTICE FOR MULCHING. HAY OR STRAW MULCH SHALL BE PLACED AT A RATE OF 90 LBS PER 1000 S.F.

5. MAINTENANCE TO ESTABLISH A STAND

- A. PLANTED AREAS SHOULD BE PROTECTED FROM DAMAGE BY FIRE, GRAZING, TRAFFIC, AND DENSE WEED
- B. FERTILIZATION NEEDS SHOULD BE DETERMINED BY ONSITE INSPECTIONS. SUPPLEMENTAL FERTILIZER IS USUALLY THE KEY TO FULLY COMPLETE THE ESTABLISHMENT OF THE STAND BECAUSE MOST PERENNIALS TAKE 2 TO 3 YEARS TO BECOME FULLY ESTABLISHED.
- C. IN WATERWAYS, CHANNELS, OR SWALES WHERE UNIFORM FLOW CONDITIONS ARE ANTICIPATED, ANNUAL MOWING MAY BE NECESSARY TO CONTROL GROWTH OF WOODY VEGETATION.

	SEEDING MIXTURE 1/	DROUGHTY	WELL DRAINED	MODERATELY WELL DRAINED	POORLY DRAINED
STEEP CUTS AND	A B	FAIR	GOOD GOOD	GOOD	FAIR FAIR
FILLS, BORROW AND DISPOSAL AREAS	Č	POOR	GOOD	FAIR EXCELLENT	GOOD
	D	FAIR	EXCELLENT	EXCELLENT	POOR
WATERWAYS, EMERGENCY SPILLWAYS, AND OTHER CHANNELS WITH FLOWING WATER.	A C	GOOD GOOD	GOOD EXCELLENT	GOOD EXCELLENT	FAIR FAIR
LIGHTLY USED PARKING LOTS, ODD AREAS, UNUSED LANDS, AND LOW INTENSITY USE RECREATION SITES.	A B C	GOOD GOOD GOOD	GOOD GOOD EXCELLENT	GOOD FAIR EXCELLENT	FAIR POOR FAIR
PLAY AREAS AND ATHLETIC FIELDS. (TOPSOIL IS ESSENTIAL FOR GOOD TURF.)	E F	FAIR FAIR	EXCELLENT EXCELLENT	EXCELLENT EXCELLENT	2/ 2/

GRAVEL PIT, SEE NH-PM-24 IN APPENDIX FOR RECOMMENDATION REGARDING RECLAMATION OF SAND AND GRAVEL PITS. / REFER TO SEEDING MIXTURES AND RATES IN TABLE BELOW.


2/ POORLY DRAINED SOILS ARE NOT DESIRABLE FOR USE AS PLAYING AREA AND ATHLETIC FIELDS.

NOTE: TEMPORARY SEED MIX FOR STABILIZATION OF TURF SHALL BE WINTER RYE OR OATS AT A RATE OF 2.5 LBS. PER 1000 S.F. AND SHALL BE PLACED PRIOR TO OCTOBER 15th, IF PERMANENT SEEDING NOT YET COMPLETE.

SEEDING GUIDE

20 20 2 42 15 10 15	0.45 0.45 0.05 0.95 0.35 0.25
2 42 15 10	0.05 0.95 0.35 0.25
42 15 10	0.95 0.35 0.25
15 10	0.35 0.25
10	0.25
1, 5	3,573.5
15	0 7E
	0.35
30	0.75
40 OR 55	0.95 OR 1.35
20	0.45
20	0.45
	0.20
48	1.10
20	0.45
30	0.75
50	1.20
50	1.15
50	1.15
100	2.30
150	3.60
	20 20 8 48 20 30 50 50 50

SEEDING RATES

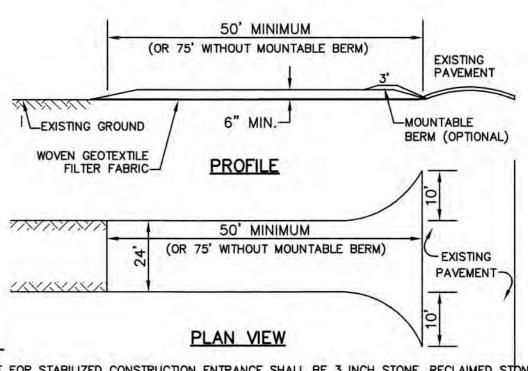

- 1. STONE FOR STABILIZED CONSTRUCTION ENTRANCE SHALL BE 3 INCH STONE, RECLAIMED STONE, OR
- RECYCLED CONCRETE EQUIVALENT. 2. THE LENGTH OF THE STABILIZED ENTRANCE SHALL NOT BE LESS THAN 50 FEET, OR 75' WITHOUT MOUNTABLE BERM, EXCEPT FOR A SINGLE RESIDENTIAL LOT WHERE A 30 FOOT MINIMUM LENGTH WOULD
- 3. THICKNESS OF THE STONE FOR THE STABILIZED ENTRANCE SHALL NOT BE LESS THAN 6 INCHES. 4. THE WIDTH OF THE ENTRANCE SHALL NOT BE LESS THAN THE FULL WIDTH OF THE ENTRANCE WHERE
- INGRESS OR EGRESS OCCURS, OR 10 FEET, WHICHEVER IS GREATER. 5. GEOTEXTILE FILTER FABRIC SHALL BE PLACED OVER THE ENTIRE AREA PRIOR TO PLACING THE STONE.
- FILTER FABRIC IS NOT REQUIRED FOR A SINGLE FAMILY RESIDENTIAL LOT. 6. ALL SURFACE WATER THAT IS FLOWING TO OR DIVERTED TOWARD THE CONSTRUCTION ENTRANCE SHALL BE
- PIPED BENEATH THE ENTRANCE. IF PIPING IS IMPRACTICAL, A STONE BERM WITH 5:1 SLOPES THAT CAN BE CROSSED BY VEHICLES MAY BE SUBSTITUTED FOR THE PIPE. 7. THE ENTRANCE SHALL BE MAINTAINED IN A CONDITION THAT WILL PREVENT TRACKING OR FLOWING OF
- SEDIMENT ONTO THE PUBLIC RIGHT-OF-WAY. THIS MAY REQUIRE PERIODIC TOP DRESSING WITH ADDITIONAL STONE AS CONDITIONS DEMAND AND REPAIR AND/OR CLEAN OUT OF ANY MEASURES USED TO TRAP SEDIMENT. ALL SEDIMENT SPILLED, WASHED, OR TRACKED ONTO THE PUBLIC RIGHT-OF-WAY MUST BE REMOVED PROMPTLY.

STABILIZED CONSTRUCTION ENTRANCE

NOT TO SCALE

CONSTRUCTION SEQUENCE

- PRIOR TO THE START OF ANY ACTIVITY, IT IS THE RESPONSIBILITY OF THE SITE'S SITE DEVELOPER (OR OWNER) TO FILE A NOTICE OF INTENT (NOI) FORM WITH THE ENVIRONMENTAL PROTECTION AGENCY (EPA) IN ORDER TO GAIN COVERAGE UNDER THE NPDES GENERAL PERMIT FOR STORM WATER DISCHARGES FROM CONSTRUCTION ACTIVITIES. A PRE CONSTRUCTION MEETING IS TO BE HELD WITH ALL DEPARTMENT HEADS PRIOR TO THE START OF CONSTRUCTION
- WETLAND BOUNDARIES ARE TO BE CLEARLY MARKED PRIOR TO THE START OF CONSTRUCTION. AT LEAST A TEMPORARY CULVERT OR ROADBED TO BE IN PLACE PRIOR TO THE START OF CONSTRUCTION.
- CUT AND REMOVE TREES IN CONSTRUCTION AREA AS REQUIRED OR DIRECTED.
- 4. INSTALL SILT FENCING, HAY BALES AND CONSTRUCTION ENTRANCES PRIOR TO THE START OF CONSTRUCTION. THESE ARE TO BE MAINTAINED UNTIL THE FINAL PAVEMENT SURFACING AND LANDSCAPING AREAS ARE ESTABLISHED.
- 5. CLEAR, CUT, GRUB AND DISPOSE OF DEBRIS IN APPROVED FACILITIES. THIS INCLUDES ANY REQUIRED DEMOLITION OF EXISTING STRUCTURES, UTILITIES, ETC.
- 6. CONSTRUCT AND/OR INSTALL TEMPORARY OR PERMANENT SEDIMENT AND/OR DETENTION BASIN(S) AS REQUIRED. THESE FACILITIES SHALL BE INSTALLED AND STABILIZED PRIOR TO DIRECTING RUN-OFF TO THEM.
- STRIP LOAM WITHIN LIMITS OF WORK PER THE RECOMMENDATIONS OF THE PROJECT ENGINEER AND STOCKPILE EXCESS MATERIAL
- STABILIZE STOCKPILE AS NECESSARY.
- 8. PERFORM PRELIMINARY SITE GRADING IN ACCORDANCE WITH THE PLANS.
- INSTALL THE DRAINAGE SYSTEM FIRST, THEN ANY OTHER UTILITIES IN ACCORDANCE WITH THE PLAN AND DETAILS. ANY CONFLICTS BETWEEN UTILITIES ARE TO BE RESOLVED WITH THE INVOLVEMENT AND APPROVAL OF THE ENGINEER.
- 10. STORMWATER FLOWS ARE NOT TO BE DIRECTED TO TREATMENT PRACTICES UNTIL ALL CONTRIBUTING AREAS HAVE BEEN FULLY STABILIZED.
- 11. DAILY, OR AS REQUIRED, CONSTRUCT TEMPORARY BERMS, DRAINAGE DITCHES, CHECK DAMS, SEDIMENT TRAPS, ETC., TO PREVENT EROSION ON THE SITE AND PREVENT ANY SILTATION OF ABUTTING WATERS AND/OR PROPERTY.
- 12. PERFORM FINAL FINE GRADING, INCLUDING PLACEMENT OF 'SELECT' SUBGRADE MATERIALS.
- 13. PAVE ALL PARKING LOTS WITH INITIAL 'BASE COURSE'.
- 14. PERFORM ALL REMAINING SITE CONSTRUCTION.
- 15. LOAM AND SEED ALL DISTURBED AREAS AND INSTALL ANY REQUIRED SEDIMENT AND EROSION CONTROL FACILITIES (i.e. RIP RAP, EROSION CONTROL BLANKETS, ETC.).
- 16. FINISH PAVING ALL PARKING AREAS WITH 'FINISH' COURSE.
- 17. ALL PARKING LOTS SHALL BE STABILIZED WITHIN 72 HOURS OF ACHIEVING FINISHED GRADE.
- 18. ALL CUT AND FILL SLOPES SHALL BE SEEDED/LOAMED WITHIN 72 HOURS OF ACHIEVING FINISHED GRADE.
- 19. COMPLETE PERMANENT SEEDING AND LANDSCAPING.
- 20. REMOVE TEMPORARY EROSION CONTROL MEASURES AFTER SEEDING AREAS HAVE BEEN 75%-85% ESTABLISHED AND SITE IMPROVEMENTS ARE COMPLETE. SMOOTH AND RE-VEGETATE ALL DISTURBED AREAS.
- 21. CLEAN SITE AND ALL DRAINAGE STRUCTURES, PIPES AND SUMPS OF ALL SILT AND DEBRIS.
- 22. INSTALL ALL PAINTED PAVEMENT MARKINGS AND SIGNAGE PER THE PLANS AND DETAILS.
- 23. ALL EROSION CONTROLS SHALL BE INSPECTED WEEKLY AND AFTER EVERY QUARTER-INCH OF RAINFALL
- 24. UPON COMPLETION OF CONSTRUCTION, IT IS THE RESPONSIBILITY OF THE CONTRACTOR TO NOTIFY ANY RELEVANT PERMITTING AGENCIES THAT THE CONSTRUCTION HAS BEEN FINISHED IN A SATISFACTORY MANNER.

Designed and Produced in NH Beach Engineers, Inc.

EROSION AND SEDIMENT CONTROL DETAILS


NEW ENGLAND PAVING ASPHALT PLANT Project: 30 SHIRKING ROAD, EPPING, NH SAM PATTERSON REAL ESTATE DEV., LLC


SHEET 7 OF JBE PROJECT NO. 14161.3

DRAWING No.

Drawing Name: 14161-PLAN-LOT26-2.dwg THIS PLAN SHALL NOT BE MODIFIED WITHOUT WRITTEN PERMISSION FROM JONES & BEACH ENGINEERS, INC. (JBE). ANY ALTERATIONS, AUTHORIZED OR OTHERWISE, SHALL BE AT THE USER'S SOLE RISK AND WITHOUT LIABILITY TO JBE.

Checked: JAC | Scale: AS NOTED | Project No.: 14161.3

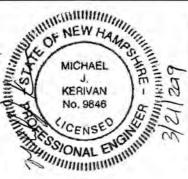

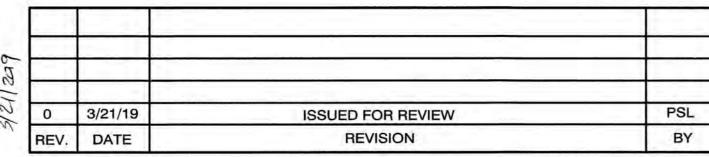

85 Portsmouth Ave. Civil Engineering Services FAX: 603-772-0227 E-MAIL: JBE@JONESANDBEACH.COM

603-772-4746

Owner of Record: PO BOX 2793, SEABROOK, NH 03874